



- APARTMENTS

n 78 E Lynn St, Seattle WA, 98102

DRAWING ISSUE

LYNN

2021.11.23 MUP INTAKE

LYNN ST APARTMENTS

DEMO EXISTING QUADPLEX; BUILD 15-UNIT APARTMENT BUILDING WITH BELOW GRADE 10-STALL GARAGE & 5 SURFACE PARKING STALLS OFF ALLEY

PROJECT #3038019-LU MUP SET SHEET TITLE

COVER SHEET

SHEET NO.

G001

Checked Checker

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LYNN ST APARTMENTS

PROJECT INFORMATION

PROJECT ADDRESS

RELATED PERMITS

OWNER

78 EAST LYNN STREET SEATTLE, WA 98102

ADMINISTRATIVE DESIGN REVIEW - 3038064-EG

MASTER USE PERMIT -BUILDING PERMIT -6836542-CN DEMO PERMIT -6836543-DM

SEPA NO SEPA REQUIRED

G & Y CHIN

PARCEL# 2902201170

PROJECT DESCRIPTION DEMO EXISTING QUADPLEX; BUILD 15-UNIT 10-STALL GARAGE & 5 SURFACE PARKING

STALLS OFF ALLEY

LOT 26, BLOCK 14 OF GREEN'S ADDITION LEGAL DESCRIPTION TO THE CITY OF SEATTLE PER PLAT

RECORDED IN VOL 2 OF PLATS, PG 73, RECORDS OF KING COUNTY

DRAWING INDEX

COVER SHEET G001 G002 PROJECT INFORMATION

GENERAL NOTES, ABBREVIATIONS, SYMBOLS G004 SMC CODE COMPLIANCE

G005 ZONING - FAR CALCULATIONS G006 ZONING - MHA CALCULATIONS G007 BUILDING CODE SUMMARY

SURVEY V001

SURVEY

CIVIL C01 CSC & SOIL AMENDMENT PLAN

DRAINAGE & WASTEWATER CONTROL PLAN - LEVEL 1

C03 DRAINAGE & WASTEWATER CONTROL PLAN - PARKING GARAGE LEVEL C04 UTILITY PLAN

C05 CSC STANDARD DETAILS

LANDSCAPE

L100 LANDSCAPE PLAN L100A RENDERED LANDSCAPE PLAN L101 LANDSCAPE LEGEND

L200 SEATTLE GREEN FACTOR PLAN L300

LANDSCAPE DETAILS

ARCHITECTURAL

SHORING SH01

A100 SITE PLAN A101 SITE LIGHTING & SIGNAGE

A200

A202 A203 **PLANS** A204 **PLANS**

A300 **ELEVATIONS ELEVATIONS ELEVATIONS COLORED ELEVATIONS**

A304 COLORED ELEVATIONS A305 COLORED ELEVATIONS A400 SECTIONS

PRELIMINARY SITE EXCVATION PLAN

SECTIONS

DRAWING ISSUE

APARTMENTS

ST

L ≺ N N

DESCRIPTION 2021.11.23 MUP INTAKE

Johnston Architects, LLC 100 NE Northlake Way,

Suite 200

Seattle, WA 98105

t 206.523.6150 f 206.523.9382

VICINITY MAP



SHEET TITLE

PROJECT INFORMATION

SHEET NO.

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CO

COL

CONC

CONT

COORD

° or DEG

DEMO

Ø or DIA

DEPT

DET

DF

DIM

DN

DR DS

DWG

DWR

EIFS

ENCL

EQUIP

ESMT

EST

EXH

EXP

EXT

FD

FM

FOC

FOF

FOIC

FOIO

FOS

FRMG

FRT

FTG

FURN

GAL

GALV

GAR

GEN

GOVT

GSM

GWB

HDR

HDW

HDWD

HLDN

HORIZ

HSS

HM

GL

GB

FDN

CPT

CT

CLEAN OUT

CONCRETE

CONTINUOUS

COORDINATE

CARPET (ED)

CERAMIC TILE

"DRYER, DEEP"

DEPARTMENT

DIAMETER

DIMENSION

DOWNSPOUT

DISHWASHER

FINISH SYSTEM

ELEVATION

ELEVATOR

EQUIPMENT

EASEMENT

EACH WAY

EXPANSION

EXTERIOR

FLOOR DRAIN

FOUNDATION

FINISH (ED)

FLASHING

FLOOR

FIRE EXTINGUISHER

FACTORY MANUAL

FACE OF FINISH

FACE OF CONCRETE

FURNISHED BY OWNER

FURNISHED BY OWNER

INSTALLED BY OWNER

FROSTPROOF HOSE BIBB

FIRE RETARDANT TREATED

"GALVANIZED, GALVANIC"

GENERAL CONTRACTOR

GLUED LAMINATED WOOD

GALVANIZED SHEET METAL

GYPSUM WALL BOARD

FACE OF MASONRY

FACE OF STUDS

FIREPLACE

"FOOT, FEET"

FRAMING

FOOTING

GALLON

GARAGE

GRAB BAR

GENERAL

GOVERNMENT

GLASS

HEIGHT

HOSE BIBB

HARDWARE

HARDWOOD

HOLDDOWN

HOLD OPEN

HORIZONTAL

SECTION

HOLLOW METAL

HOLLOW STRUCTURAL

AIR CONDITIONING"

INSIDE DIAMETER

HOT WATER HEATER

"HEATING, VENTILATION, AND

HEADER

FURNITURE

NATURAL GAS

INSTALLED BY CONTRACTOR

EXHAUST

ESTIMATE (D)

ELECTRIC (AL)

ENCLOSE (URE)

DRAWING

DRAWER

EXISTING

DECIBEL

DOWN

"DEMOLISH, DEMOLITION"

DRINKING FOUNTAIN

"DINING ROOM, DOOR'

EXTERIOR INSULATION AND

FLUID APPLIED MEMBRANE

CASEMENT

COLUMN

<u>ABB</u>	<u>REVIATIONS</u>				
#	NUMBER	ΙΕ	INVERT ELEVATION	TBD	TO BE DETERMINED
4	ANGLE	IIC	IMPACT ISOLATION CLASS	TEL	TELEPHONE
AB	ANCHOR BOLT	IN	INCH (S)	TEMP	TEMPORARY
ABS	ACRYLONITRILE BUTADIENE	INCL	INCLUDING (ED)	TFF	TOP OF FINISH FLOOR
	STYRENE	INFO	INFORMATION	THK	THICK (NESS)
ACST	ACOUSTICAL	INSUL	INSULATION	THRU	THROUGH
ADA	AMERICANS WITH	INT	INTERIOR	TOB	TOP OF BEAM
	DISABILITIES ACT	JAN	JANITOR	TOC	TOP OF CURB
ADDL	ADDITIONAL	JST	JOIST (S)	TOW	TOP OF WALL
ADJ	ADJUSTABLE	KIT	KITCHEN	TV	TELEVISION
AFF	ABOVE FINISH FLOOR	KW	KILOWATT	TYP	TYPICAL
AP	ACCESS PANEL	L	LENGTH	UBC	UNIFORM BUILDING CODE
APPROX	APPROXIMATE	LAM	LAMINATE(D), LIQUID APPLIED	UL	UNDERWRITERS
APT	APARTMENT		MEMBRANE		LABORATORIES
ARCH	ARCHITECT (URAL)	LAV	LAVATORY	UNO	UNLESS NOTED OTHERWISE
ASTM	AMERICAN SOCIETY FO	LB (S)	POUND (S)	UTIL	UTILITY
	TESTING MATERIALS	LF	LINEAL FOOT/FEET	VCT	VINYL COMPOSITION TILE
AWI	ARCHITECTURAL	LH	LEFT HAND	VERT	VERTICAL
	WOODWORKING INSTITUTE	LHR	LEFT HAND REVERSE	VIF	VERIFY IN FIELD
BD	BOARD	LNDSCP	LANDSCAPE	V	VOLT
BITUM	BITUMINOUS	LOC	LOCATION	W	"WEST, WIDTH, WASHER"
BLDG	BUILDING	LR LTG	LIVING ROOM	W/	WITH
BLKG	BLOCKING	LVL	LIGHTING	W/D	WASHER / DRYER WITHOUT
BM	BEAM	MACH RM	LAMINATED VENEER LUMBER	W/O	WATER CLOSET
ВО	BOTTOM OF	MAG RIVI	MACHINE ROOM MAGNET(IC)	WC WD	"WOOD, WOOD DOOR"
BOF	BOTTOM OF FOOTING	MATL	MATERIAL	WDW	WINDOW
BR	BEDROOM	MAX	MAXIMUM	WRB	WEATHER RESISTIVE BARRIER
BSMT	BASEMENT	MB	MAILBOX	WND	WEATHER RESISTIVE BARRIER
Btu	BRITISH THERMAL UNIT	MBR	MASTER BEDROOM		
CAB CB	CATCLERACIN	MC	MEDICINE CABINET	6 \ 7 \ 7	
C.C.	CATCH BASIN CENTER TO CENTER	MECH	MECHANICAL	SYM	IBOL LEGEND
CFM	CUBIC FEET PER MINUTE	MEMB	MEMBRANE	0110	DOL LLOLIND
CFOI	CONTRACTOR FURNISHED;	MEP	MECHANICAL, ELECTRICAL,		_
CFOI	OWNER INSTALLED	IVILI	PLUMBING		
СН	CHANNEL	MEZZ	MEZZANINE		(4)
CI	CAST IRON	MFD	MANUFACTURED		NEW C
CIP	CAST INON CAST-IN-PLACE (CONCRETE)	MFR	MANUFACTURER		————(E) NEW C
CL	CENTERLINE	MIN	"MINIMUM, MINUTE"		
CLG	CEILING	MIRR	MIRROR		
CLR	CLEAR	MISC	MISCELLANEOUS		$\sqrt{\mathbf{v}}$
CMU	CONCRETE MASONRY UNIT	MO	MASONRY OPENING		$\langle X \rangle$ _
CO	OLEAN OUT	MTI	METAL		T V EVIST/

METAL

NEW

MULLION

MULTIPLE

NUMBER

NOMINAL

OVERALL

ON CENTER

DIMENSION"

OVERHANG

OPENING

OVERHEAD

PEDESTAL

PERIMETER

PERMANENT

PLYWOOD

PRECAST

PARKING

PROJECT

PAINTED

TREATED"

PAVING

QUANTITY

RECESSED

REQUIRED

RESILIENT

ROOM

SOUTH

SHEET

SIMIL AR

STANDPIPE

SPRINKLER

SQUARE

SPECIFICATION

SQUARE INCH

"SANITARY SEWER,

STANDING SEAM"

STAINLESS STEEL

"STAIRS, STREET"

STRUCTURE (AL)

TONGUE AND GROOVE

SUSPEND(ED)

SHEET VINYL

STANDARD

STORAGE

STEEL

SOUND TRANSMISSION CLASS

SCHEDULE

STORM DRAIN

"REFER (ENCE),

REFRIGERATOR"

"RADIUS, RISER"

PARTITION

POLYVINYL ACRYLIC

POLYVINYL CHLORIDE

"ROOF DRAIN, ROAD"

"REINFORCE (D), (ING)"

"REVISION (S), REVISED"

RIGHT HAND REVERSE

ROUGH OPENING

RAINWATER LEADER

SQUARE FOOT (FEET)

RIGHT OF WAY

"ROOF HATCH, RIGHT HAND"

REVOLUTIONS PER MINUTE

SELF-ADHERED MEMBRANE

REFLECTED CEILING PLAN

PROPERTY

PHASE

PERPENDICULAR

PROPERTY LINE

PREFABRICATED

POUNDS PER SQUARE FOOT

POUNDS PER SQUARE INCH

PARALLEL STRAND LUMBER

"POST-TENSIONED, PRESSURE

PRELIMINARY

PLASTIC LAMINATE

PERFORATED

OPPOSITE HAND

PARTICLE BOARD

OFFICE

NOT TO SCALE

"OUTSIDE DIAMETER,

OVERFLOW ROOF DRAIN

PORTLAND CEMENT PLASTER

NORTH

NOT APPLICABLE

NOT IN CONTRACT

MULL

MULT

NTS

OD

OPP HAND

OPNG

ORD

PCP

PED

PERF

PERIM

PERM

PLWD

PRCST

PRELIM

PRKG

PSI

PSL

PVC

QTY

RCP

REQD

RESIL

SPKLR

SQ IN

STC

STD

STOR

SUSP

STRUCT

OVHD

MATERIAL LEGEND

EARTH, UNDISTURBED	
EARTH, COMPACTED FILL	
SAND, GROUT	
POROUS FILL	
CONCRETE	4 4 4 4 4 4 4
CEMENTITIOUS UNDERLAYMENT	
BRICK COMMON/FACE	
CONCRETE MASONRY UNITS	
ASHLER STONE	
ALUMINIUM	
STEEL, OTHER METALS	
PLYWOOD	
WOOD BLOCKING OR SHIM	
WOOD FRAMING, CONTINUOUS	
GLUED-LAMINATED WOOD	
ORIENTED STRAND BOARD	
PARTICLEBOARD	
FINISHED WOOD	
BATT INSULATION	
RIGID INSULATION	
SPRAY FOAM INSULATION	



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ARTMENTS

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N | | | DRAWING ISSUE

DESCRIPTION 2021.11.23 MUP INTAKE

GENERAL NOTES

NEW COLUMN GRIDS

EXIST/ADJ BLDG

NORTH ARROW

BUILDING ELEVATION

DRAWING NUMBER

DRAWING NUMBER

BUILDING SECTION

DRAWING NUMBER

DRAWING NUMBER

SHEET NUMBER

SPOT ELEVATION

DRAWING SHT.

SHOWING ADJ. CONDITION

DATUM / CONTROL POINT

REVISED CONTOURS

EXISTING CONTOURS

WALL TO BE REMOVED

CEILING HEIGHT TAG

NEW WALL

FINISH TAG

ROOM TAG

DOOR TAG

WINDOW TAG

ASSEMBLY TAG

REVISION TAG /

REVISION CLOUD

FIRE EXTINGUISHER

SMOKE DETECTOR

EXIT SIGN

(WALL, FLOOR, CLG, ROOF)

EXISTING WALL

SHEET NUMBER

A210-

_ - - - - - - - - - - - -

8'-0"

0101A

MATCH LINE

SEE XX/X-XXX

DRAWING NUMBE

SHEET NUMBER

SHEET NUMBER

SHEET NUMBER

1.A THE CONTRACTOR SHALL BE GOVERNED BY ALL CONDITIONS AS INDICATED IN THE CONSTRUCTION DRAWINGS AND SPECIFICATIONS.

- 1.B THE CONTRACTOR SHALL BE RESPONSIBLE FOR SAFETY IN THE AREA OF WORK IN ACCORDANCE WITH ALL APPLICABLE SAFETY CODES.
- 1.C THE CONTRACTOR SHALL INDEMNIFY AND HOLD JOHNSTON ARCHITECTS HARMLESS FOR INJURY OR DEATH TO PERSONS OR FOR DAMAGE TO PROPERTY CAUSED BY NEGLIGENCE OF CONTRACTOR, HIS AGENT, EMPLOYEES OR SUBCONTRACTORS.
- 1.D EACH CONTRACTOR/SUBCONTRACTOR IS RESPONSIBLE FOR ANY DAMAGE TO ADJACENT WORK AND IS RESPONSIBLE FOR THE REPAIR OF SAID DAMAGE AT THEIR OWN EXPENSE.
- 1.E THE CONTRACTOR SHALL REPORT ERRORS AND OMISSIONS TO THE ARCHITECT IMMEDIATELY IN WRITING. DO NOT VARY OR MODIFY THE WORK SHOWN EXCEPT UPON WRITTEN INSTRUCTIONS OF THE ARCHITECT.
- 1.F THE CONTRACTOR SHALL BE RESPONSIBLE FOR PROVIDING ALL WALL BLOCKING AS REQUIRED FOR ALL WALL AND CEILING MOUNTED ITEMS. COORDINATE WITH THE ARCHITECT AND/OR OWNER LOCATION OF ALL MOUNTED ITEMS WHICH ARE N.I.C
- 1.G ALL CONSTRUCTION SHALL BE STABILIZED AGAINST LATERAL MOVEMENT IN ACCORDANCE WITH REQUIREMENTS OF THE LATEST ADOPTED EDITION OF THE U.B.C. IN THE LOCAL JURISDICTION AND IN STRICT ACCORDANCE WITH THE STRUCTURAL DETAILS OF THIS SET OF DRAWINGS.
- 1.H ALL WORK SHALL BE INSTALLED TRUE, PLUM, SQUARE, LEVEL AND IN PROPER ALIGNMENT.
- OFFSET STUDS WHERE REQUIRED SO THAT FINISH WALL SURFACES WILL BE FLUSH.
- MECHANICAL, ELECTRICAL, VERTICAL TRANSPORTATION, & SPRINKLER WORK CONDUCTED UNDER SEPARATE PERMIT & NOT PART OF THIS CONTRACT.
- INSTALL ALL FIXTURES, EQUIPMENT, AND MATERIALS PER MANUFACTURER'S
- SPECIFICATION.
- 1.M CLEAN AND READY FOR THEIR INTENDED USE. CONTRACTOR SHALL GUARANTEE ALL WORK AGAINST FAULT OF ANY MATERIAL OR WORKMANSHIP FOR PERIOD OF ONE YEAR AFTER COMPLETION AND ACCEPTANCE.

EACH CONTRACTOR/SUBCONRACTOR SHALL BE RESPONSIBLE FOR LEAVING ALL AREAS

FAULTY WORK SHALL BE REPLACED OR REPAIRED AS REQUIRED AT CONTRACTOR'S EXPENSE.

2. CODES:

2.A ALL WORK SHALL BE IN COMPLIANCE WITH ALL APPLICABLE FEDERAL, STATE, AND LOCAL CODES INCLUDING BUT NOT LIMITED TO THE 2018 SBC, THE GOVERNNING ENERGY CODE AND MECHANICAL CODE WITHIN THE JURISDICTION OF THE PROJECT. IN CASE OF CONFLICT WHERE METHODS OR STANDARDS OF INSTALLATION OR MATERIALS SPECIFIED DO NOT EQUAL OR EXCEED THE REQUIREMENTS OF THE LAWS OR ORDINANCES, THE ORDINANCES SHALL GOVERN. NOTIFY THE ARCHITECT OF ANY

2.B IT IS THE RESPONSIBILITY OF THE GENERAL CONTRACTOR AND EACH AND EVERY SUBTRADE TO INSURE EVERY ASPECT OF THIS WORK IS IN COMPLIANCE WITH THE PREVAILING CODES.

3. DRAWINGS:

- 3.A THESE DRAWINGS ARE THE EXCLUSIVE PROPERTY OF THE ARCHITECT. AUTHORIZED REPRODUCTION MUST BEAR THE NAME OF THE FIRM.
- PRIOR TO PROCEEDING WITH ANY WORK. DRAWINGS INDICATE GENERAL AND TYPICAL DETAILS OF CONSTRUCTION, WHERE CONDITIONS ARE NOT SPECIFICALLY INDICATED BUT ARE SIMILAR CHARACTER TO

3.B IN CASE OF DISCREPANCY OR AMBIGUITY, CONTACT THE ARCHITECT FOR CLARIFICATION

- DETAILS SHOWN, SIMILAR DETAILS OF CONSTRUCTION SHALL BE USED ONLY SUBJECT TO REVIEW AND APPROVAL BY THE ARCHITECT.
- CONTRACTOR SHALL FURNISH SHOP DRAWINGS FOR THE ARCHITECT'S APPROVAL PRIOR 3.D TO MANUFACTURE OF ANY CABINET WORK, MILLWORK AND ANY OTHER SPECIAL ITEMS REQUIRING CUSTOM SHOP FABRICATED WORK.
- DRAWINGS INCLUDE ABBREVIATIONS WHICH ARE IN COMMON USE. THE LIST OF ABBREVIATIONS PROVIDED IS NOT INTENDED TO BE COMPLETE OR REPRESENTATIVE OF CONDITIONS OR MATERIALS SPECIFICALLY USED ON THE PROJECT. THE ARCHITECT WILL DEFINE THE INTENT OF ANY DEFINITION OR TERM IN QUESTION.

4. SUPPLEMENTARY DRAWINGS AND SPECIFICATIONS:

4.A STRUCTURAL, PLUMBING, MECHANICAL, ELECTRICAL AND FIRE PROTECTION DRAWINGS ARE SUPPLEMENTARY TO THESE DRAWINGS. THE CONTRACTOR SHALL COORDINATE THE WORK OF EACH CONSULTING ENGINEER WITH THESE DRAWINGS OR SPECIFICATIONS AND SHALL NOTIFY THE ARCHITECT OF ALL DISCREPANCIES WITH A WRITTEN REQUEST FOR CLARIFICATION. ANY WORK INSTALLED IN CONFLICT WITH THESE CONTRACTO DOCUMENTS SHALL BE CORRECTED SOLELY AT THE EXPENSE OF THE CONTRACTOR.

5. DIMENSIONS:

- 5.A <u>DO NOT SCALE THESE DRAWINGS.</u> ALL INFORMATION SHOWN ON THE DRAWINGS RELATIVE TO EXISTING CONDITIONS IS GIVEN AS THE BEST PRESENT KNOWLEDGE BUT WITHOUT GUARANTEE OF ACCURACY. THE CONTRACTOR SHALL FIELD VERIFY EXISTING CONDITIONS AND DIMENSIONS AND SHALL NOTIFY THE ARCHITECT OF ANY DISCREPANCIES OR CONDITIONS ADVERSELY EFFECTING THE DESIGN PRIOR TO PROCEEDING WITH THE ITEM OF WORK EFFECTED.
- 5.B DIMENSIONS ON THE PLANS ARE TO FACE OF STRUCTURE, UNLESS OTHERWISE NOTED.

6. COORDINATION:

6.A THE GENERAL CONTRACTOR SHALL BE RESPONSIBLE FOR THE VERIFICATION AND COORDINATION OF THE WORK OF ALL TRADES TO ASSURE COMPLIANCE WITH THE DRAWINGS AND SPECIFICATIONS.

7. FIRE PROTECTION:

- 7.A FIRE PROTECTION CONTRACTORS SHALL PROVIDE FIRE PROTECTION DRAWINGS REQUIRED BY GOVERNING AUTHORITY. DRAWINGS SHOULD BE SUBMITTED TO THE ARCHITECT FOR REVIEW.
- 7.B PROVIDE FIRE PROTECTION AT ALL PENETRATIONS OF FIRE RATED ELEMENTS REQUIRED BY THE FIRE OFFICIAL.
- 7.C EXISTING FIRE ALARM SYSTEMS SHALL REMAIN INTACT AND OPERABLE AT ALL TIMES.

8. ELECTRICAL NOTES:

- 8.A THE ELECTRICAL CONTRACTOR SHALL BE RESPONSIBLE FOR MAINTAINING COMPLIANCE WITH ALL CODES AND OBTAINING ALL NECESSARY PERMITS.
- 8.B ALL DEVIATIONS FROM DIMENSIONED LOCATIONS MUST BE APPROVED BY THE
- 8.C THE ELECTRICAL CONTRACTOR SHALL VERIFY THE LOCATION OF EACH CORE DRILL WITH THE EXISTING STRUCTURE, PIPING, CONDUIT, ETC. AND SHALL NOTIFY THE ARCHITECT OF ANY CONFLICTS OR OBSTRUCTIONS.
- 8.D ANY DISCREPANCIES BETWEEN EXISTING CONDITIONS AND CONTRACT DOCUMENTS SHOULD BE CALLED TO THE ATTENTION OF THE ARCHITECT.
- 8.E ALL NEW ELECTRICAL/TELEPHONE OUTLETS ARE TO BE MOUNTED VERTICALLY AT 15" AFF UNLESS NOTED. ALL WALL MOUNTED RECEPTACLES LOCATED IN CASEWORK ARE TO BE MOUNTED HORIZONTALLY UNLESS OTHERWISE NOTED.
- 8.F SPECIAL HEIGHTS ARE NOTED ADJACENT TO THE OUTLET.
- 8.G THE ELECTRICAL CONTRACTOR SHALL BE RESPONSIBLE FOR MAINTAINING COMPLIANCE WITH ALL ADA REQUIREMENTS FOR HEIGHTS OF FIXTURES AND DEVICES (I.E. SWITCHES, OUTLETS ETC.)

9. MECHANICAL NOTES

- 9.A ALL HVAC SYSTEMS ARE TO COMPLY WITH ALL APPLICABLE CODES, AND ARE NOT PART OF THIS CONTRACT.
- 9.B THE CONTRACTOR SHALL VERIFY SIZES AND LOCATIONS OF ALL OPENINGS FOR MECHANICAL EQUIPMENT WITH MECHANICAL DRAWINGS AS WELL AS SHOP DRAWINGS BEFORE PROCEEDING WITH WORK.

<u>10. FINISH NOTES:</u>

10.A ALL FINISH MATERIAL COLORS SHALL MATCH ARCHITECT'S CONTROL SAMPLES AND REQUIRE THE ARCHITECT'S APPROVAL PRIOR TO INSTALLATION.

SHEET TITLE GENERAL NOTES, ABBREVIATIONS, SYMBOLS

SHEET NO.

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STREET TO THE CONTAINERS;

CLEARANCE SHALL BE PROVIDED

MINIMUM OF 10 FEET WIDE;

b. ANY GATES OR ACCESS ROUTES FOR TRUCKS SHALL BE A

LANE DESIGNATED AS A SOLE TRAVEL LANE FOR A BUS;

c. COLLECTION LOCATION SHALL NOT BE WITHIN A BUS STOP OR WITHIN THE STREET RIGHT-OF-WAY AREA ABUTTING A VEHICULAR

d. IF ACCESSED DIRECTLY BY A COLLECTION VEHICLE, WHETHER INTO A STRUCTURE OR OTHERWISE, A 24 FOOT OVERHEAD

5. FLOOR AREA RATIO (FAR):
SMC 23.45.510, TABLE A


SEATTLE MUNICIPAL CODE REQUIREMENT

FOR LR3 ZONES WITH AN MHA SUFFIX INSIDE URBAN CENTERS AND URBAN VILLAGES, FAR IS 2.3
PROPOSED: SEE DIAGRAMS SHEET G005

6. SETBACKS AND SEPERATIONS
SMC 23.45.518., TABLE A
FRONT - 5' MINIMUM
REAR - 10' MINIMUM WITH ALLEY
SIDE - 7' AVERAGE; 5' MINIMUM
(FOR FACADES GREATER THAN 40' IN LENGTH)

AN UPPER-LEVEL SETBACK OF 12 FEET FROM THE FRONT LOT LINE IS REQUIRED FOR ALL PORTIONS OF A STRUCTURE ABOVE THE FOLLOWING HEIGHT:

2) 54 FEET FOR ZONE WITH A HEIGHT LIMIT OF 50 FEET

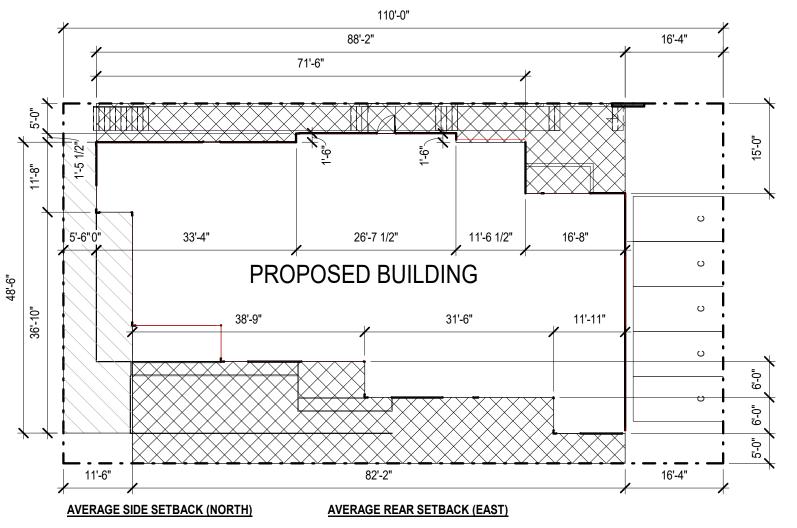

674.81 SF / 88.17' = 5.00' MIN; 7.65' AVG 16.34' AVG

AVERAGE SIDE SETBACK (SOUTH)

AVERAGE FRONT SETBACK (WEST)

1094.83 SF / 82.17' = 5.00' MIN; 13.32' AVG

487.75 SF / 48.50' = 5.00' MIN; 10.06' AVG

3 SETBACK DIAGRAM - SMC


7. AMENITY AREA

SMC 23.45.522.A

SMC 23.45.518.A.2.a

AMOUNT OF AMENITY AREA REQUIRED FOR ROWHOUSE AND TOWNHOUSE DEVELOPMENTS AND APARTMENTS IN LR ZONES:

1. THE REQUIRED AMOUNT OF AMENITY AREA FOR ROWHOUSE AND TOWNHOUSE AND APARTMENTS IN LR ZONES IS EQUAL TO 25% OF THE LOT AREA 2. A MINIMUM OF 50% OF THE REQUIRED AMENTIY AREA SHALL BE PROVIDED AT GROUND LEVEL, EXCEPT THAT AMENITY AREA PROVIDED ON THE ROOF OF A STRUCTURE THAT MEETS THE PROVISIONS OF 23.45.510.D.5 MAY BE COUNTED AS AMENITY AREA PROVIDED AT GROUND LEVEL 4. FOR APARTMENTS, AMENITY AREA REQUIRED AT GROUND LEVEL SHALL BE PROVIDED AS COMMON SPACE.

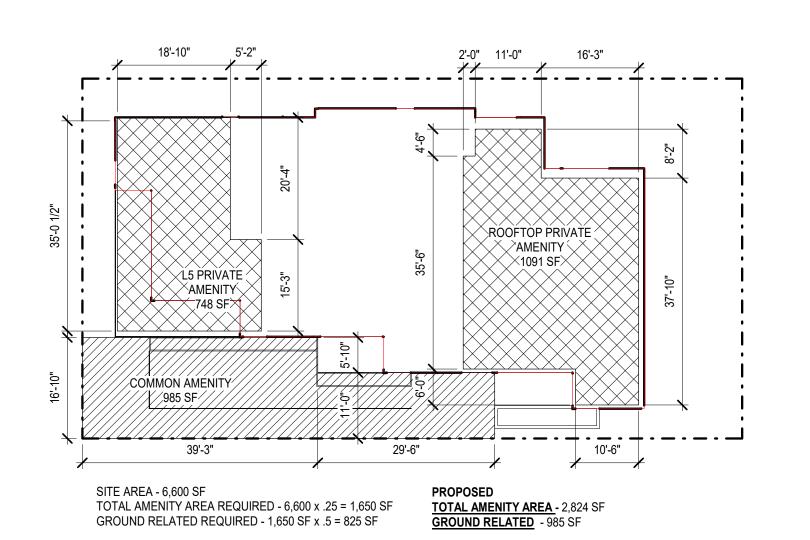

AMENITY AREA - SMC

ZONING CODE SUMMARY

SMC 23.45.514.I.6.

1. ZONING DESIGNATION: LR3(M1) 2. SITE AREA: 6,600 SF 3. USES IN COMMERCIAL ZONES ALL RESIDENTIAL USES PERMITTED SMC 23.45.504, TABLE A 4. STRUCTURE HEIGHT APARTMENTS IN LR3 IN URBAN CENTERS, URBAN VILLAGES, SMC 23.45.514, TABLE A AND STATION AREA OVERLAY DISTRICTS, HEIGHT LIMIT IS 50' (WITH MANDATORY HOUSING AFFORDABILITY SUFFIX) PROPOSED: 43.38' (SECTION 1) & 49.52' (SECTION 2) SEE ELEVATIONS FOR MORE INFORMATION SMC 23.45.514.G ROOF SURFACES THAT ARE COMPLETELY SURROUNDED BY A PARAPET MAY EXCEED THE APPLICABLE HEIGHT LIMIT TO ALLOW FOR A SLOPE, PROVIDED THAT THE HEIGHT OF THE HIGHEST ELEVATION OF THE ROOF STRUCTURE DOES NOT EXCEED 75% OF THE PARAPET HEIGHT, AND PROVIDED THAT THE LOWEST ELEVATION OF THE ROOF STRUCTURE IS NO HIGHER THAN THE APPLICABLE HEIGHT LIMIT. SMC 23.45.514.I.2. OPEN RAILINGS, PLANTERS, GREENHOUSES NOT DEDICATED TO FOOD PRODUCTION, PARAPETS, AND FIREWALLS ON THE ROOFS OF PRICIPLE STRUCTURES MAY EXTEND 4' ABOVE THE MAXIMIM HEIGHT LIMIT SET IN SUBSECTIONS 23.45.514.A, 23.45.514.B., AND 23.45.514.F. SMC 23.45.514.I.4. IN LR ZONES, THE FOLLOWING ROOFTOP FEATURES MAY EXTEND 10 FEET ABOVE THE HEIGHT LIMIT SET IN SUBSECTIONS

SEATTLE MUNICIPAL CODE REQUIREMENT


23.45.514.A AND 23.45.514.F, IF THE COMBINED TOTAL COVERAGE OF ALL FEATURES OF SUBSECTION 23.45.514.J.4.a THROUGH 23.45.514.J.4.f DOES NOT EXCEED 15% OF THE ROOF AREA (OR 20% OF THE ROOF AREA IF THE TOTAL INCLUDED SCREENED MECHANICAL EQUIPMENT):


a. STAIR PENTHOUSES, EXCEPT AS PROVIDED IN

SUBSECTION 23.45.514.I.6;
b. MECHANICAL EQUIPMENT;
c. PLAY EQUIPMENT AND OPEN-MESH FENCING THAT
ENCLOSES IT, IF THE FENCING IS AT LEAST 5 FEET FROM THE
ROOF EDGE;
d. CHIMNEYS
e. WIND-DRIVEN POWER GENERATORS; AND
f. MINOR COMMUNICATION LITH ITIES AND ACCESSORY

f. MINOR COMMUNICATION UTILITIES AND ACCESSORY
COMMUNICATION DEVICES, EXCEPT THAT HEIGHT IS
REGULATED ACCORDING TO THE PROVISIONS OF SECTION
23.57.011
PROPOSED: 7.45%

SUBJECT TO THE ROOF COVERAGE LIMITS IN SUBSECTIONS 23.45.514.1.4 AND 23.45.514.1.5, ELEVATOR PENTHOUSES MAY EXTEND ABOVE THE APPLICABLE HEIGHT LIMIT UP TO 16 FEET. STAIR PENTHOUSES MAY BE THE SAME HEIGHT AS AN ELEVATOR PENTHOUSE IF THE ELEVATOR AND STAIRS ARE COLOCATED WITHIN A COMMON PENTHOUSE STRUCTURE. SEE ELEVATIONS FOR MORE INFORMATION.

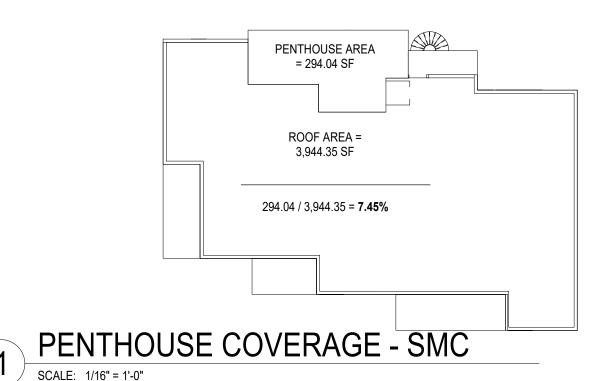

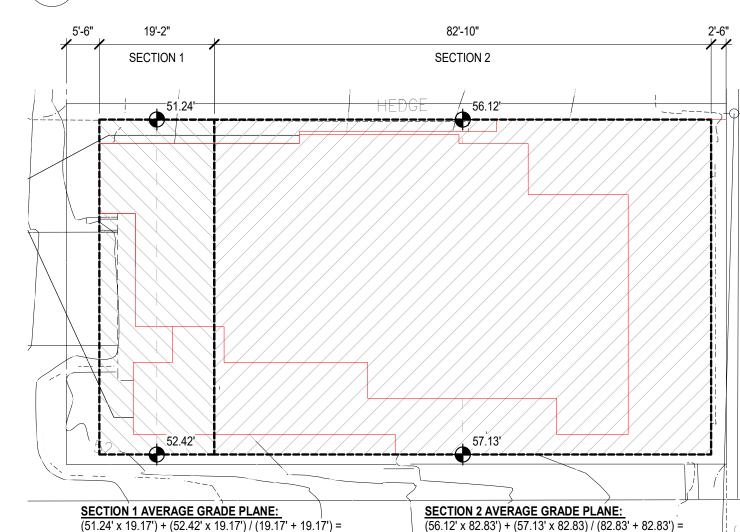

-(4,648.42 + 4,732.08) / 165.66 = :\(\)

9,380.5 / 165.66 = **56.63**'

AVERAGE GRADE PLANE - SMC

-(982.27 + 1,004.89) / 38.34 = -

1,987.16 / 38.34 = **51.83**'

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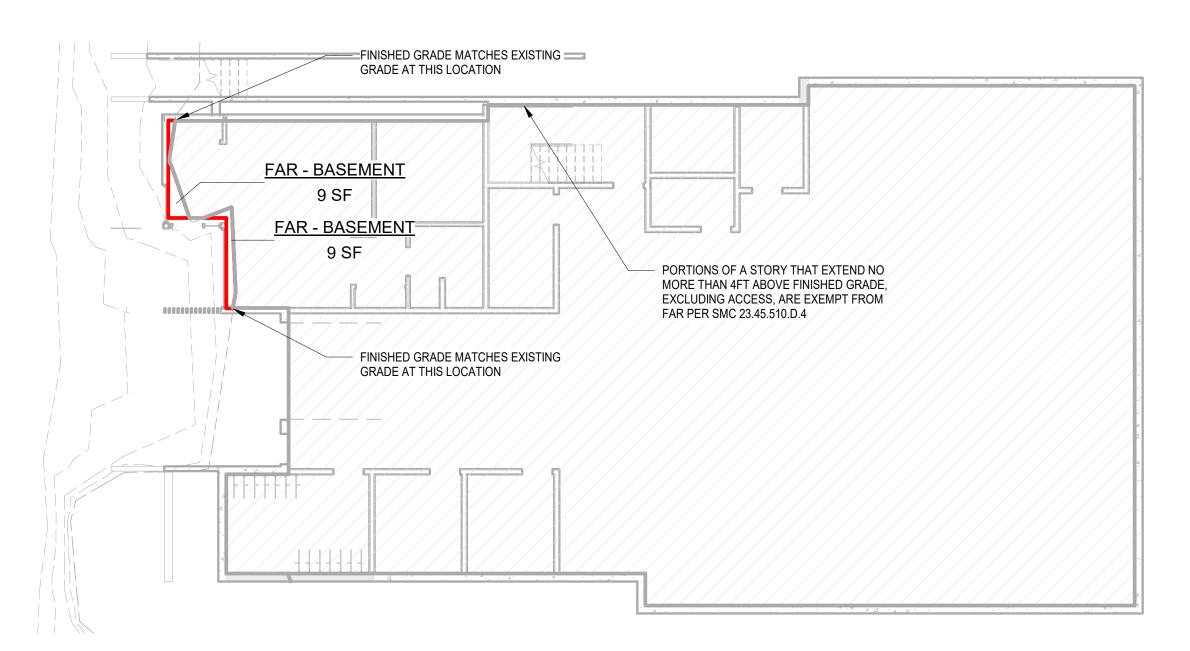
SHEET TITLE

SMC CODE COMPLIANCE

SHEET NO.

G004

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BASEMENT - FAR SCALE T - IF OT 1154 115

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- 1. DIMENSIONS ARE TO INSIDE FACE OF FRAMING OF EXTERIOR WALLS PER SMC 23.86.007.E
- 2. ALL UNDERGROUND STORIES OR PORTIONS OF STORIES THAT ARE UNDERGROUND ARE EXEMPT FROM FAR PER SMC 23.45.510.D.4
- 3. PORTIONS OF A STORY THAT EXTEND NO MORE THAN 4FT ABOVE EXISTING OR FINISHED GRADE, WHICHEVER IS LOWER, EXCLUDING ACCESS ARE EXEMPT FROM FAR PER SMC 23.45.510.D.4
- 4. FAR EXCLUDES BALCONIES, PATIOS, & DECKS W/ A SINGLE DWELLING UNIT; GROUND-LEVEL WALKING PATHS PER SMC 23.45.510.A

AREA SCHEDI	JLE (FAR)
AREA NAME	AREA
FAR - BASEMENT	18 SF

AREA NAME	AREA
FAR - BASEMENT	18 SF
FAR - LEVEL 1	3082 SF
FAR - LEVEL 2	3084 SF
FAR - LEVEL 3	3088 SF
FAR - LEVEL 4	3088 SF
FAR - LEVEL 5	2477 SF
FAR - PENTHOUSE	183 SF
	15020 SF


FLOOR AREA RATIO CALCS (SMC 23.45.510):


ZONE: LR3(M1) **SITE AREA**: 6,600 SF

MAX FAR ALLOWED: 2.3 (PER SMC 23.45.510, TABLE A) = 2.3 x SITE AREA = 2.3 x 6,600 SF = 15,180 MAX FAR


PROPOSED FAR: 15,020SF

15,020 SF / 6,600 SF = 2.276 FAR

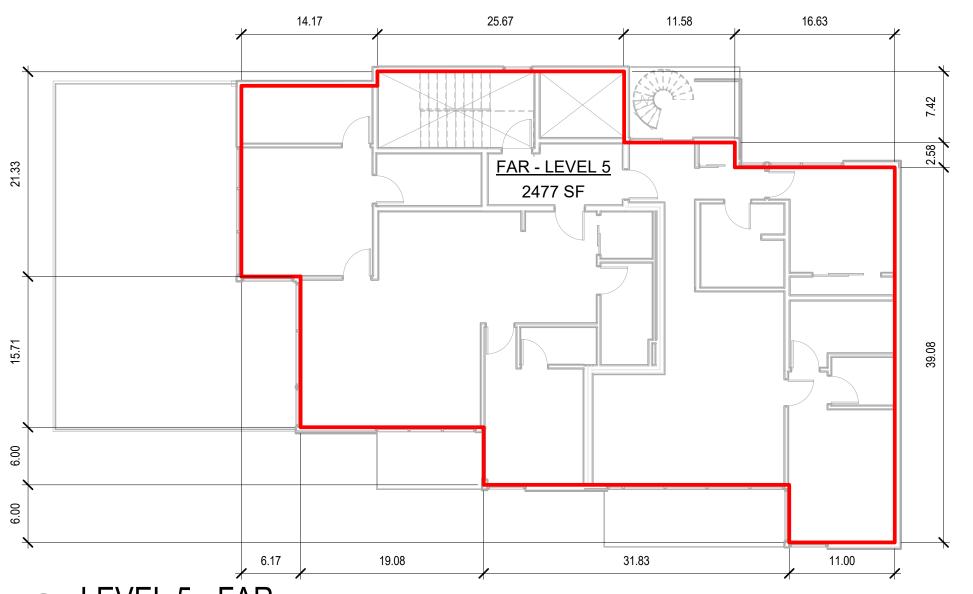

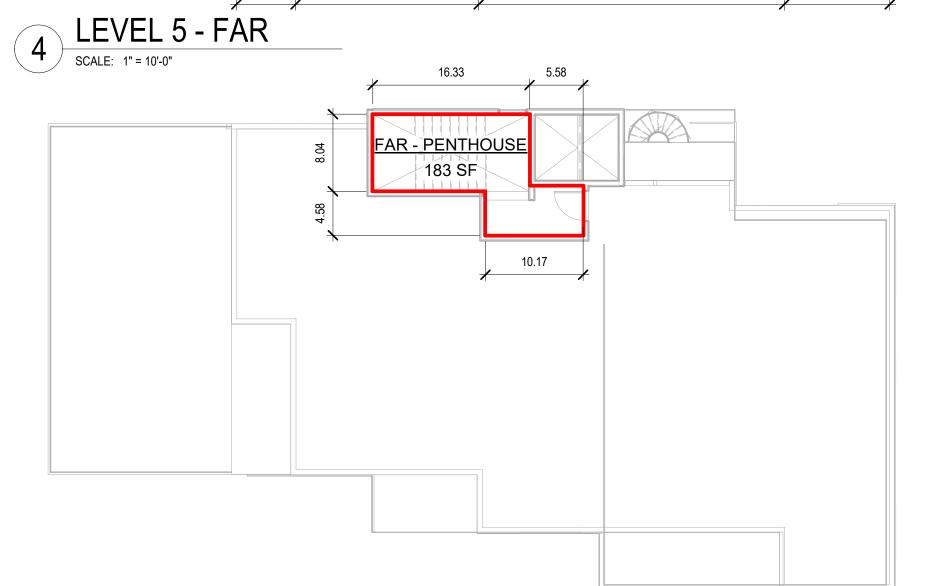



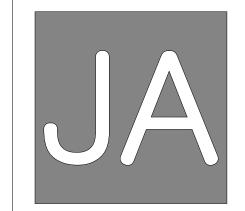

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ARTMENTS

78 E Lynn St, Seattle WA, 9810

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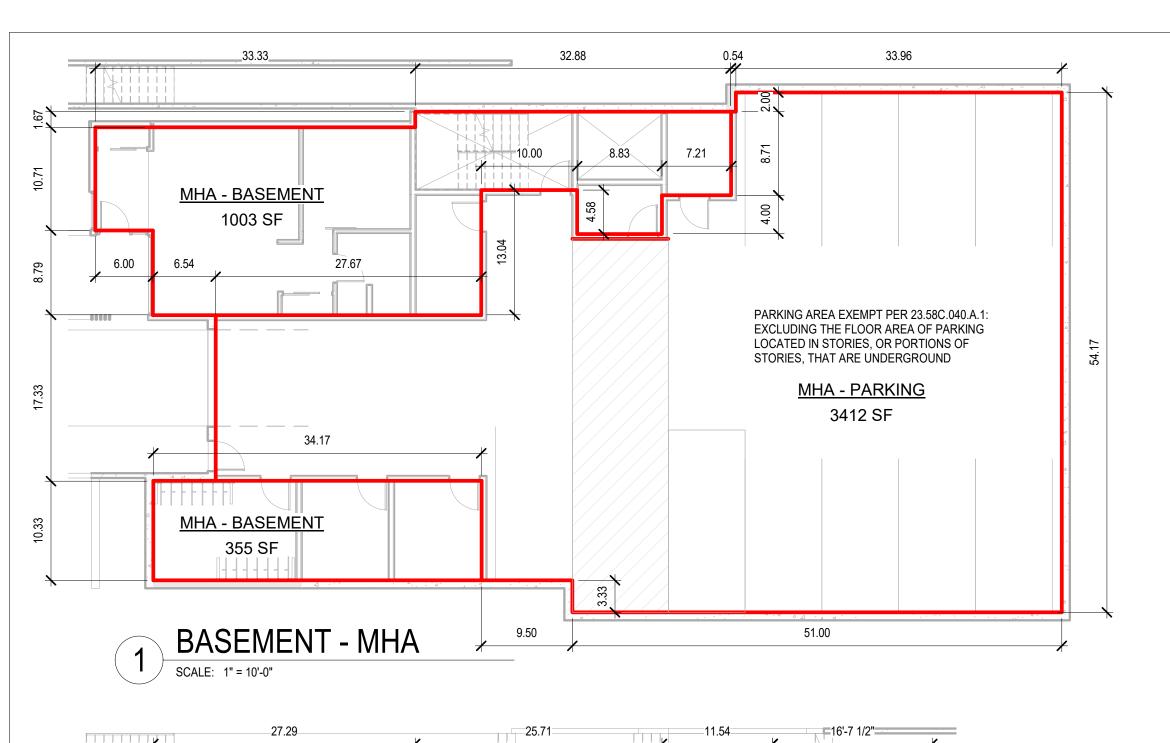
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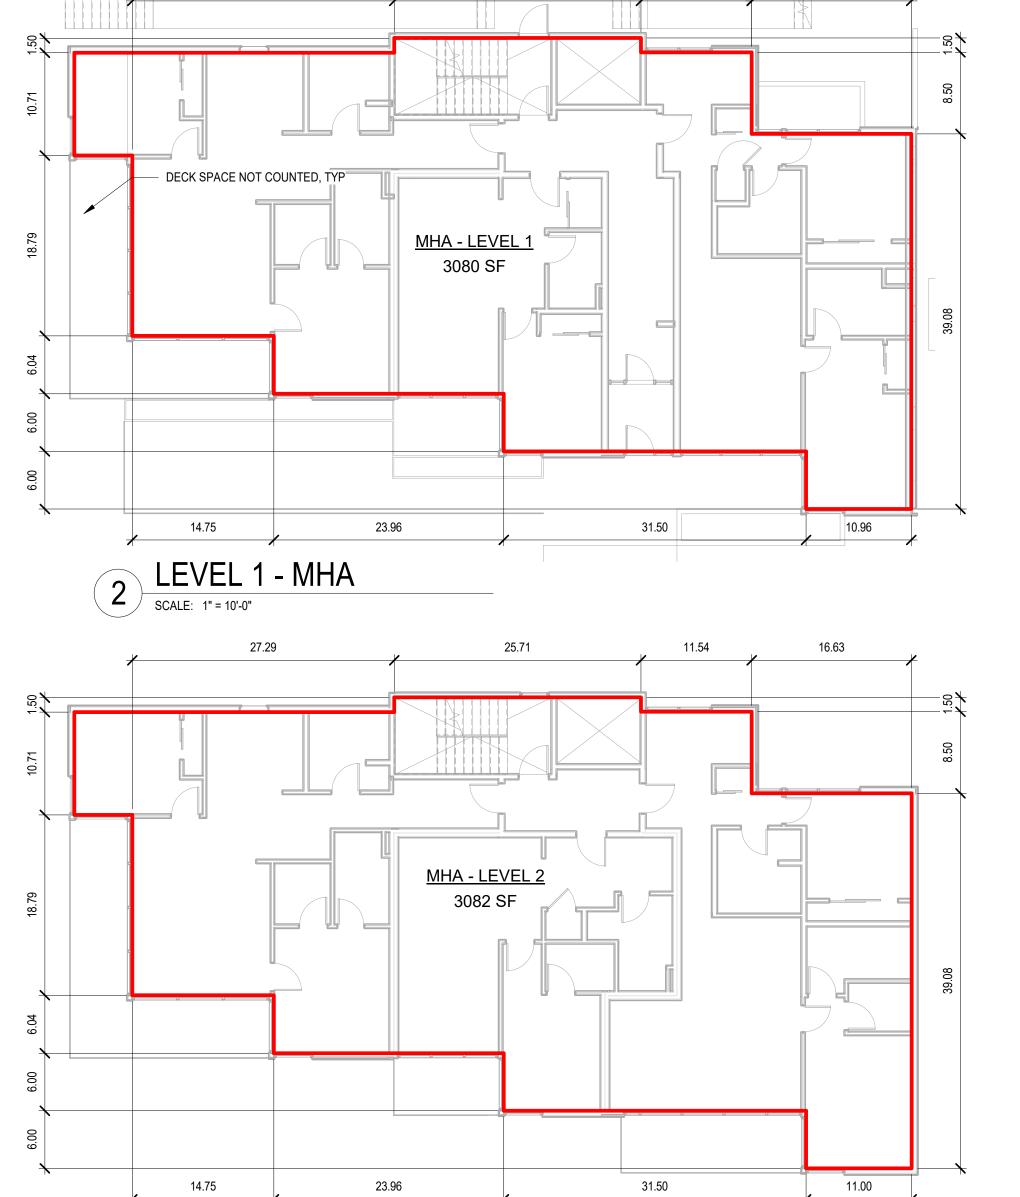
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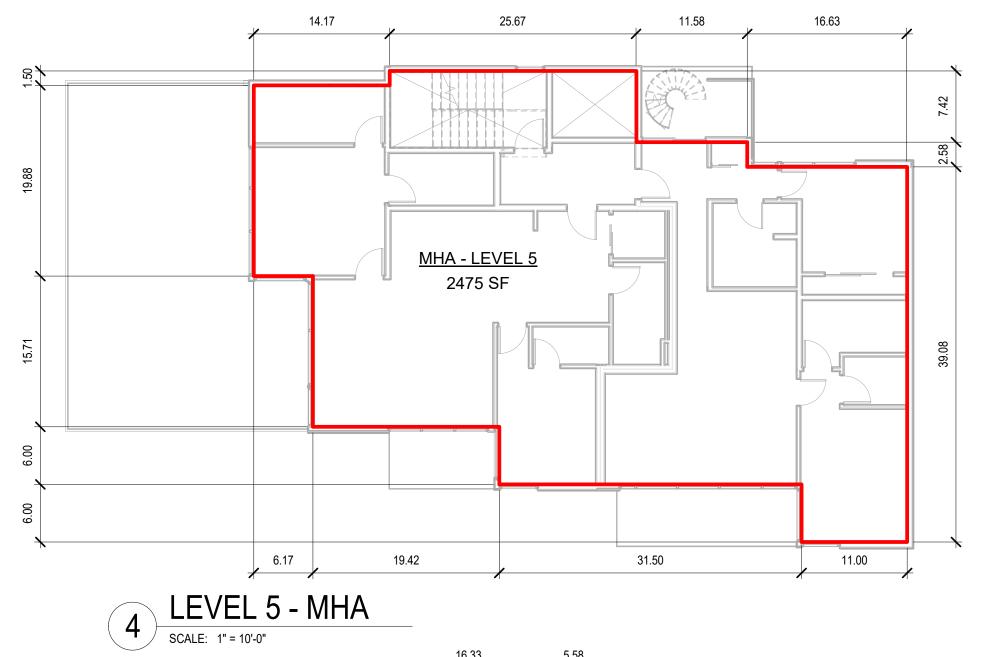





MHA-R PAYMENT OPTION SUMMARY TABLE

AREA SCHEI	DULE (MHA)	1	ZONE
LEVEL	AREA	2	MHA AREA DESIGNATION (PER MAP A, 23.58C.050)
- BASEMENT	1358 SF	3	ASSOCIATED PUDA?
- LEVEL 1	3080 SF	_	TOTAL # OF DEGIDENTIAL ALL WEARING DIVINITO
LEVEL 2	3082 SF	4	TOTAL # OF RESIDENTIAL & LIVE/WORK UNITS
LEVEL 3	3122 SF	5	GROSS FLOOR AREA* IN RESIDENTIAL USE
LEVEL 4	3122 SF	-	
- LEVEL 5 - PENTHOUSE	2475 SF 183 SF	6	GROSS FLOOR AREA LIVE/WORK UNITS
- PENTHOUSE	16421 SF	7	GROSS FLOOR AREA EXCLUDED FROM MHA-R PAYMENT (SMC 23.58C.040)
REA SCHEDULE	(MHA) - EXEMPT	8	FLOOR AREA FOR MHA-R CALCULATION [(LINE 5 + LINE 6) - LINE 7]
LEVEL	AREA	9	ADJUSTED PAYMENT CALCULATION AMOUNT
	T	7	PER CODE (PER TABLE 4, TIP 257)
- Parking	3412 SF 3412 SF	10	MHA-R PAYMENT DUE (LINE 8 x LINE 9)

* PER 23.84A.014 "G.": "GROSS FLOOR AREA" MEANS THE NUMBER OF SQUARE FEET OF TOTAL FLOOR AREA BOUNDED BY THE INSIDE SURFACE OF THE EXTERIOR WALL OF THE STRUCTURE AS MEASURED AT THE FLOOR LINE, AND ANY ADDITIONAL AREAS INDENTIFIED AS GROSS FLOOR AREA WITHIN A ZONE.



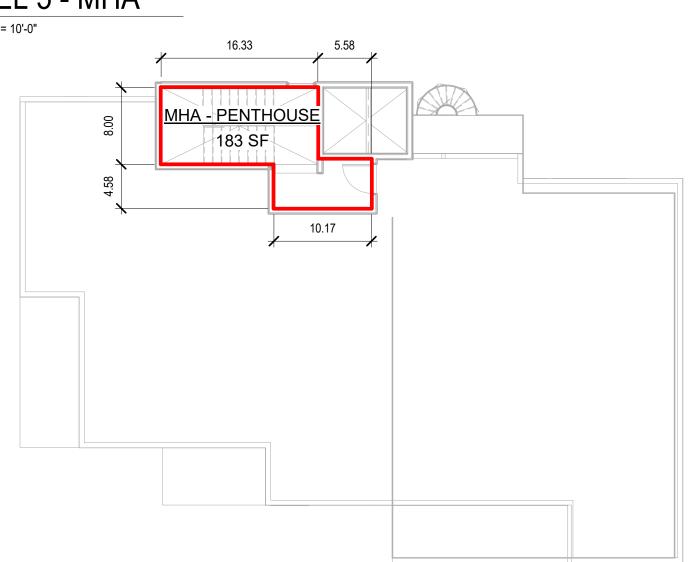





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ZONING - MHA CALCULATIONS

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3 LEVEL 2, 3, 4 - MHA

SCALE: 1" = 10'-0"

CHAPTER 10: MEANS OF EGRESS (CON'T)

1015: GUARDS

- OPERABLE WINDOWS WITH SILLS MORE THAN 72" ABOVE GRADE SHALL COMPLY WITH 1013.8 (THE LOWEST PART OF THE CLEAR OPENING SHALL NOT BE LESS THAN 36" ABOVE FINISHED FLOOR OR IF WITHIN 36" OF THE FLOOR, CANNOT ALLOW PASSAGE OF A 4" SPHERE VIA AN OPENING LIMITING DEVICE)

- GUARDS ARE REQ'D AT ALL OPEN SIDED WALKING SURFACES MORE THAN 30" ABOVE AN ADJACENT SURFACE AT ANY POINT WITHIN 36" HORIZONTALLY - GUARDS SHALL BE 42" HIGH MIN

- GUARDS SHALL NOT HAVE OPENINGS WHICH ALLOW THE PASSAGE OF A 4" DIA SPHERE; THE TRIANGULAR OPENING AT STAIR RISERS/TREADS SHALL NOT ALLOW THE PASSAGE OF A 6" DIA SPHERE

- IN GROUP R, CORRIDORS REQUIRE A 1 HR RATING

- DEAD END CORRIDOR LENGTH CANNOT EXCEED 50 FT IN GROUP R-2 WITH AUTOMATIC SPRINKLERS

1028: EXIT DISCHARGE:

- EXITS SHALL DISCHARGE DIRECTLY TO THE EXTERIOR OF THE BUILDING

- EXIT DISCHARGE SHALL PROVIDE DIRECT AND UNOBSTRUCTED ACCESS TO A PUBLIC WAY - EGRESS COURTS SERVING AS A PORTION OF EXIT DISCHARGE SHALL BE OF A MIN WIDTH AS SPEC'D IN SECTION 1005, BUT NOT LESS THAN 44" (44" WIDTH GOVERNS). WIDTH SHALL BE UNOBSTRUCTED TO A HEIGHT OF 7"

> WHERE AN EGRESS COURT IS LESS THAN 10' WIDE, EGRESS COURT WALLS REQUIRE A 1 HR MIN FIRE RATING FOR 10 VERT FT ABOVE THE COURT FLOOR. OPENINGS SHALL BE PROTECTED BY A 3/4 HR MIN RATING, UNLESS IT IS POSSIBLE TO EXIT IN TWO DIRECTIONS FROM THE COURT (PER 1028.4.2 EXC 3)

NOTE: EXIT IN 2 DIRECTIONS IS PROVIDED

1030: EMERGENCY ESCAPE AND RESCUE

- BASEMENTS AND SLEEPING ROOMS BELOW THE 4TH STORY ABOVE GRADE PLANE SHALL HAVE AT LEAST ONE EXTERIOR EMERGENCY ESCAPE AND RESCUE OPENING

- MIN SIZE = MIN NET CLEAR OPENING OF 5.7 SF - MIN DIMS = 24" HIGH, 20" WIDE

- MAX HEIGHT ABOVE THE FLOOR = 44" TO BOTTOM OF CLEAR OPENING

- WINDOW WELLS MUST HAVE A MIN DIM (IN PLAN) OF 36". WELLS > 44" DEEP REQUIRE A PERMANENT LADDER

CHAPTER 11: ACCESSIBILITY

1101: GENERAL: MEET REQUIREMENTS OF ICC A117.1 (SEE SHEET A700)

1103.2.9: EQUIPMENT SPACES: SPACES FREQUENTED ONLY BY PERSONNEL FOR MAINTENANCE, REPAIR, OR MONITORING OF EQUIP ARE NOT REQ'D TO BE ACCESSIBLE. SUCH SPACES INCLUDE, BUT ARE NOT LIMITED TO, ELEVATOR PITS, ELEVATOR PENTHOUSES, MECH, ELEC, OR COMM EQUIP ROOMS, WATER PUMP ROOMS, AND TRANSFORMER VAULTS

1105: ACCESSIBLE ENTRANCES:

- AT LEAST 60% OF ALL PUBLIC ENTRANCES SHALL BE ACCESSIBLE

- IN GROUP R-2 OCCUPANCIES CONTAINING MORE THAN 10 UNITS, AT LEAST 5% (BUT NOT LESS THAN 1) SHALL BE TYPE A UNITS OF A REPRESENTATIVE MIX

UNIT MIX OF PROJECT

UNIT TYPE	COUNT	PERCENT		UNIT TYPE	COUNT	PERCENT
1-BR B	1	33%		2-BR C	3	67%
1-BR C	3	33%		2-BR D	1	67%
2-BR A	1	67%		2-BR E	1	67%
2-BR B	4	67%		OPEN 1-BR A	1	33%
	•	'	_	ΤΟΤΔΙ	15	•

PROPOSED TYPE A UNITS: 15 x 0.05 = 0.75 (1 TYPE A UNITS REQUIRED) 1 UNIT PROVIDED: 2 BED - UNIT 103

- WHERE THERE ARE 4+ UNITS IN A SINGLE STRUCTURE, EVERY OTHER UNIT SHALL BE A TYPE B UNIT

CHAPTER 12: INTERIOR ENVIRONMENT

1207: SOUND TRANSMISSION

- UNIT PARTY WALLS AND CORRIDOR WALLS SHALL HAVE A STC RATING OF AT LEAST 50 AND AN IIC RATING OF AT

- UNIT ENTRY DOORS AT THE CORRIDOR SHALL HAVE PERIMETER SEALS AND A STC RATING OF AT LEAST 28 - ELECTRICAL OUTLET BOXES SHALL BE OFFSET BY AT LEAST 12" FROM OUTLETS ON THE OPPOSING WALL SURFACE. INCH FIBER INSULATION

1208: INTERIOR SPACE DIMENSIONS:

- HABITABLE SPACES (OTHER THAN A KITCHEN) REQUIRE A MIN PLAN DIMENSION OF 7 FT

- HABITABLE SPACES REQUIRE A CEILING HEIGHT OF 7'-6" OR MORE. BATHROOMS, KITCHENS, STORAGE AND LAUNDRY AREAS ARE PERMITTED TO BE 7'-0" TALL

- EVERY DWELLING UNIT NEEDS ONE ROOM OF AT LEAST 120 SF SIZE; OTHER HABITABLE ROOMS (OTHER THAN KITCHEN) REQUIRE A 70 SF MIN FLOOR AREA

CHAPTER 15: ROOFTOP ASSEMBLIES AND ROOFTOP STRUCTURE

1507: SINGLE-PLY ROOFING SLOPE: MIN 1/4" IN 12" (2%) SLOPE REQ'D

- PENTHOUSES IN COMPLIANCE WITH THIS SECTION SHALL BE CONSIDERED A PORTION OF THE STORY DIRECTLY

BELOW THE ROOF DECK ON WHICH SUCH PENTHOUSES ARE LOCATED - HEIGHT ABOVE ROOF DECK: 18 FT MAX

- AGGREGATE AREA SHALL NOT EXCEED ONE-THIRD OF ROOF BELOW

- PENTHOUSES SHALL NOT BE USED FOR PURPOSES OTHER THAN SHELTER OF MEP EQUIP, EXIT STAIRWAYS, OR VERTICAL SHAFT OPENINGS

CHAPTER 24: GLASS AND GLAZING

2406: SAFETY GLAZING (IE: TEMPERED GLASS) IS REQUIRED AT THE FOLLOWING HAZARDOUS LOCATIONS:

- GLAZING IN ALL FIXED AND OPERABLE PANELS OF SWINGING, SLIDING, AND BIFOLD DOORS - GLAZING WITHIN 24" OF A DOOR AND WHERE THE BOTTOM EDGE OF THE GLASS IS LESS THAN 60" ABOVETHE

ADJACENT WALKING SURFACE - GLAZING WITHIN 18" OF THE FLOORS

- GLAZING IN RAILS OR GUARDS

- GLAZING IN WALLS OR ENCLOSURES CONTAINING OR FACING, OR WITHIN 60" OF TUBS OR SHOWERS WHERE

THE BOTTOM EDGE IS LESS THAN 60" ABOVE THE FLOOR - GLAZING WHERE THE BOTTOM EDGE IS LESS THAN 60" ABOVE STAIRS, RAMPS, OR LANDINGS

CHAPTER 30: ELEVATORS AND CONVEYING SYSTEMS

3016.9: INSTALL APPROVED KEY RETAINER BOX, KEYED TO THE SECURE CITY KEY

3016.10: KEYS REQUIRED FOR THE OPERATION OF THE ELEVATOR, FIRE EMERGENCY SERVICE, THE MACHINE ROOM, AND THE MECHANICAL HOISTWAY ACCESS KEY SHALL BE TAGGED AND KEPT IN THE KEY BOX

3016.12: IN BULDINGS 4 OR MORE STORIES IN HEIGHT, AT LEAST ONE ELEVATOR SHALL BE PROVIDED FOR FIRE DEPARTMENT EMERGENCY ACCESS TO ALL FLOORS AND ACCOMMODATE A 24" x 84" STRETCHER W/5" RADIUS

3020.3: MOTOR CONTROLLERS, MOTION CONTROLLERS, AND DRIVES SHALL NOT BE LOCATED IN HOISTWAYS

3020.4: ELEVATOR CONTROLS AND MACHINERY OTHER THAN DRIVING MACHINES AND GOVERNORS SHALL BE LOCATED IN A ROOM DEDICATED EXCLUSIVELY TO ELEVATOR EQUIPMENT. ELEVATOR MACHINE ROOMS THAT ARE ADJACENT TO THE HOISTWAY SHALL BE ENCLOSED BY FIRE PARTITIONS AND HORIZONTAL ASSEMBLIES WITH A FIRE RESISTANCE RATING EQUAL TO THE HOISTWAY (2 HR), BUT THE SEPARATION BETWEEN THE ROOM AND THE HOISTWAY IS PERMITTED TO BE NONRATED. EXTERIOR WALLS AND ROOFS ARE NOT REQUIRED TO BE FIRE-RATED UNLESS REQUIRED BY OTHER SECTIONS OF THE CODE

3022.1: IN ACCORDANCE WITH ASME A 17.1 SECTION 2.8, NON-ELEVATOR ELECTRIC WIRING, PIPES AND DUCTS ARE PROHIBITED IN ELEVATOR MACHINE ROOMS AND HOISTWAYS

CHAPTER 7: FIRE AND SMOKE PROTECTION FEATURES (CON'T)

705.8.5: VERTICAL SEPARATION OF OPENINGS: SEPARATION NOT REQ'D IF BLDG IS EQUIPPED WITH AN AUTOMATIC SPRINKLER

705.11: PARAPETS: A 30" TALL PARAPET IS NOT REQUIRED AT MAIN ROOF IF BLDG IS SPRINKLERED AND EXTERIOR WALLS HAVE A SEPARATION DISTANCE OF 5' OR GREATER (PER EXCEPTION 6)

- SHAFT ENCLOSURES SHALL HAVE A FIRE-RESISTANCE RATING OF NOT LESS THAN 2 HOURS WHERE CONNECTING MORE THAN

- WHERE AN EXTERIOR WALL SERVES AS PART OF THE REQ'D SHAFT ENCLOSURE, EXTERIOR WALLS SHALL COMPLY WITH SECTION 705 FOR EXTERIOR WALLS, EXCEPT INTERIOR EXIT STAIRWAYS, WHICH SHALL COMPLY WITH SEC 1022.7

 REFUSE AND RECYCLING CHUTE ACCESS OPENINGS SHALL NOT BE LOCATED DIRECTLY IN CORRIDORS. ACCESS OPENINGS SHALL BE LOCATED IN ROOMS/COMPARTMENTS ENCLOSED BY 1 HR FIRE BARRIERS W/ 3/4 HR SELFCLOSING DOORS - ENCLOSED ELEVATOR LOBBIES NOT REQ'D WHERE BLDG IS PROTECTED BY AUTOMATIC SPRINKLER SYSTEM PER 713.14. EXC 4

CHAPTER 9: FIRE PROTECTION SYSTEMS

903: AUTOMATIC SPRINKLER SYSTEMS: FULL NFPA 13 AUTOMATIC SPRINKLER SYSTEM IS REQUIRED

906: PORTABLE FIRE EXTINGUISHERS: SHALL BE PROVIDED THROUGHOUT IN GROUP R-2 OCCUPANCY FIRE EXTINGUISHERS FOR

CLASS A, ORDINARY HAZARD OCCUPANCIES: - MIN RATED SINGLE EXTINGUISHER: 2-A

- MAX FLOOR AREA PER UNIT OF A: 1,500 SF - MAX FLOOR AREA PER EXTINGUISHER: 11,250 SF

- MAX TRAVEL DISTANCE: 75 FT

- SHALL BE PROTECTED FROM SERVICE INTERUPTION PER NFPA 20 SHALL BE LOCATED IN A SEPARATE ROOM W/ 1-HOUR FIRE BARRIERS IN BLDGS EQUIPPED W/ AN AUTOMATIC SPRINKLER

- ROOM TEMP OF FIRE PUMP ROOM MUST REMAIN ABOVE 40 DEGREES FARENHEIT

CHAPTER 10: MEANS OF EGRESS (SEE ALSO SHEET G008)

1003: CLEAR HEIGHT: MEANS OF EGRESS SHALL HAVE A CEILING HEIGHT NOT LESS THAN 7'-6" HIGH, EXCEPT AT STAIRS WHICH CAN HAVE A 6'-8" CLEAR HT PER 1009.5 AND DOORS

1004.1.2: OCCUPANT LOAD

STORAGE/MECH/EQUIP AREAS =

ASSEMBLY (UNCONCENTRATED TABLES & CHAIRS) = 15 NET 200 GROSS

*OUTDOOR AREAS ASSOCIATED WITH R-2 INDIVIDUAL DWELLING UNITS ARE EXEMPT FROM OCCUPANT LOAD FACTORS PER 1004.5 EXC 2

1005: MEANS OF EGRESS SIZING

PARKING AREAS =

- STAIR WIDTH MIN (SPRINKLER EXCEPTION) = 0.2" PER OCCUPANT

0.2" X 20 OCC (LEVEL 5) = 4.00" SECTION 1009.1 GOVERNS = 44" MIN WIDTH

- WHEN FULLY OPENED, DOORS SHALL NOT REDUCE THE REQ'D WIDTH BY MORE THAN 7" PER 1005.7

1015.1: SPACES WITH ONE EXIT: GROUP R MAX OCCUPANT LOAD: 10

A SINGLE EXIT OR ACCESS TO A SINGLE EXIT SHALL BE PERMITTED FROM ANY STORY OR OCCUPIED ROOF WHERE THE FOLLOWING EXISTS:

- NOT MORE THEN 5 STORIES OF GROUP R-2 OCCUPANCY ARE PERMITTED TO BE SERVED BY A SINGLE EXIT

- NOT MORE THAN FOUR DWELLING UNITS ON ANY FLOOR - NOT MORE THAN 20 FT OF TRAVEL TO THE EXIT STAIR FROM THE ENTRY/EXIT DOOR OF ANY DWELLING UNIT

- NO OPENINGS WITHIN 10 FT OF UNPROTECTED OPENINGS INTO THE STAIRWAY OTHER THAN REQUIRED EXIT DOORS HAVING A ONE-HOUR FIRE RESISTANCE RATING

1006.2: COMMON PATH OF EGRESS TRAVEL (WITH SPRINKLER SYSTEM): GROUP R-2 MAX TRAVEL DISTANCE: 125 FT GROUP S-2 MAX TRAVEL DISTANCE: 100 FT

1006.3: EXIT ACCESS TRAVEL DISTANCE (WITH SPRINKLER SYSTEM): GROUP R-2 MAX TRAVEL DISTANCE: 125 FT GROUP S-2 MAX TRAVEL DISTANCE: 100 FT

1008: MEANS OF EGRESS ILLUMINATION - MEANS OF EGRESS AND EXIT DISCHARGE SHALL BE ILLUMINATED AT ALL TIMES THAT THE BLDG IS OCCUPIED. AT LEAST

ONE LIGHT FIXTURE IS REQ'D PER STAIR LANDING AND OUTSIDE THE BLDG EXIT. AT LEAST 1 FIXTURE IS REQ'D EVERY 40

LINEAL FEET OF CORRIDOR, AND AT LEAST 1 FIXTURE PER 250 SF OF LOBBIES, VESTIBULES, AND ELEVATOR CARS. ILLUM SHALL BE AT LEAST 0.1 WATT OF FLUORESCENT ILLUM PER SF (x3 IF INCANDESCENT) - EMERGENCY POWER/AUTO ILLUMINATION IS REQ'D FOR 90 MINS IN THE EVENT OF POWER FAILURE IN CORRIDORS AND EXIT

1009: ACCESSIBLE MEANS OF EGRESS

- AN ELEVATOR COMPLYING WITH 1007.4 IS THE REQ'D ACCESSIBLE MEANS OF EGRESS BECAUSE OCCUPIED ROOF IS 4 STORIES ABOVE THE LEVEL OF EXIT DISCHARGE. A LEGALLY-REQUIRED STANDBY POWER SYSTEM SHALL BE PROVIDED FOR OPERATION OF THE ELEVATOR, THE SHUNT TRIP AND LIGHTING FOR ELEVATOR CARS, CONTROL ROOMS, MACHINE ROOMS,

- AN AREA OF REFUGE OR HORIZONTAL EXIT IS NOT REQ'D IN BUILDINGS WITH AN AUTOMATIC SPRINKLER SYSTEM PER 1009.4 - TWO-WAY COMMUNICATION SYSTEM SHALL BE PROVIDED AT EACH ELEVATOR LANDING ON EACH ACCESSIBLE FLOOR THAT

IS ONE OR MORE STORIES ABOVE THE LEVEL OF EXIT DISCHARGE 1010.1.6: LANDINGS AT DOORS: WHEN DOORS OPEN OVER LANDINGS, DOORS IN ANY POSITION SHALL NOT REDUCE THE

STANDING LENGTH TO LESS THAN 12 INCHES. LANDINGS SHALL HAVE A LENGTH MEASURED IN THE DIRECTION OF TRAVEL OF

1011: STAIRWAYS - STAIR RISER HEIGHTS SHALL BE 7" MAX AND 4" MIN; STAIR TREAD DEPTH SHALL BE 11" MIN

- THE TOLERANCE BETWEEN THE LARGEST/SMALLEST RISER AND LARGEST/SMALLEST TREAD DEPTH IS 3/8"/FLIGHT - EXIT STAIRS ACTING AS AN ACCESSIBLE MEANS OF EGRESS MUST HAVE SOLID RISERS - A FLIGHT OF STAIRS SHALL NOT HAVE A VERTICAL RISE GREATER THAN 12 FT BETWEEN FLOOR LEVELS/LANDINGS

- HANDRAILS ARE REQUIRED AT EACH SIDE - WITHIN GROUP R-2 OCCUPANCIES, THE MAX RISER HEIGHT SHALL BE 7-3/4", THE MIN DEPTH SHALL BE 10"

- SPIRAL STAIRWAYS ARE PERMITTED TO BE USED AS A COMPONENT IN THE MEANS OF EGRESS ONLY WITHIN DWELLING UNITS NOT SERVING MORE THAN FIVE OCCUPANTS

- SPIRAL STAIRWAY SHALL HAVE A 6-3/4" MIN CLEAR TREAD DEPTH AT A POINT 12" FROM THE NARROW EDGE; RISERS SHALL PROVIDE HEADROOM OF 78" MIN BUT RISER HEIGHT SHALL NOT BE MORE THAN 9-1/2"; MIN STAIRWAY WIDTH AT AND BELOW HANDRAIL SHALL BE 26"

1013: EXIT SIGNS: ARE REQ'D PER SECTION 1013

- HANDRAIL HEIGHT AT STAIRS AND RAMPS SHALL BE UNIFORM BETWEEN 34" AND 38" ABOVE STAIR TREAD NOSINGS - HANDRAILS WITH A CIRCULAR CROSS SECTION SHALL HAVE A DIAMETER BETWEEN 1.25" AND 2" AND HAVE A 1.5" CLEARANCE FROM THE WALL

- HANDRAILS SHALL BE CONTINUOUS AND RETURN TO A WALL, GUARD, OR WALKING SURFACE OR BE CONTINUOUS BETWEEN RUNS. WHERE HANDRAILS ARE NOT CONTINOUS BETWEEN FLIGHTS, THEY SHALL EXTEND 12" HORIZ BEYOND THE TOP RISER AND CONTINUE TO SLOPE FOR THE DEPTH OF ONE TREAD BELOW THE BOTTOM RISER - HANDRAIL PROJECTIONS SHALL NOT EXCEED 4.5" AT OR BELOW HANDRAIL HEIGHT

CHAPTER 5: BUILDING HEIGHT AND AREA (CON'T)

PROPOSED BLDG: SPRINKLERED, 5-STORY (51.936' HT ABOVE GRADE PLANE TO ROOF) TYPE VA,

HEIGHT ALLOWED: 50 FT + 20 FT SPRINKLER INCREASE = 70 FT HEIGHT PROPOSED: 51.936 FT

STORIES ALLOWED: 4 STORIES + 1 STORY SPRINKLER INCREASE = 5 STORIES STORIES PROVIDED: 5

AREA ALLOWED: 12,000 + 12,000*2 (SPRINKLER)= 36,000 SF PER STORY 36,000 PER STORY x 3 = 108,000 MAX BUILDING AREA

3,229 SF MAX PER STORY 20,768 SF TOTAL BUILDING AREA

AREA SCHEDULE (GROSS BUILDING) LEVEL AREA TYPE VA **BASEMENT** 4946 SF 3229 SF LEVEL 2 3229 SF LEVEL 3 3229 SF LEVEL 4 3229 SF LEVEL 5 2612 SF **PENTHOUSE** 292 SF 20768 SF

20768 SF

509: INCIDENTAL USES: INCIDENTAL USES (IE: STORAGE) SHALL NOT OCCUPY MORE THAN 10 PERCENT OF THE AREA OF THE STORY IN WHICH THEY ARE LOCATED, OR THEY MUST COMPLY WITH TABLE 509 OR 508.4:

FURNACE ROOM (GREATER THAN 400,000 BTU PER HR): 1 HR OR SPRINKLER PROTECTION (T 509) BOILER ROOMS (15 PSI OR 10 HP OR GREATER): 1 HR OR SPRINKLER PROTECTION (T 509) WASTE COLLECTION ROOMS (GREATER THAN 100 SF): 1 HR OR SPRINKLER PROTECTION (T 509) **ELEVATOR CONTROL AND MACHINE ROOMS:** PER 3020.4 STORAGE (S-2) 1 HR (508.4)

CHAPTER 6: TYPES OF CONSTRUCTION

TOTAL

602: FIRE-RESISTANCE RATING REQUIREMENTS FOR BUILDING ELEMENTS

	TYPE VA
STRUCT FRAME:	1 HR
BEARING WALLS EXT:	1 HR
BEARING WALLS INT:	1 HR
NON-BEAR WALLS EXT:	SEE TABLE 602 (BELOW)
NON-BEAR WALLS INT:	0 HR
FLOORS:	1 HR
ROOF:	1 HR
SHAFTS:	2 HR
CORRIDORS:	1/2 HR (1 HR REQ' D PER 1018)

602: FIRE-RESISTANCE RATING FOR EXTERIOR WALLS BASED ON FIRE SEPARATION DISTANCE

FIRE SEP DISTANCE:	TYPE OF CONST:	GROUP R
<5	VA	1 HR
≥5 <10	VA	1 HR
≥10 <30	VA	1 HR
≥30	ALL	0 HR


CHAPTER 7: FIRE AND SMOKE PROTECTION FEATURES

705: EXTERIOR WALL PROJECTIONS:

- EAVE OVERHANGS FROM RATED WALLS SHALL BE FINISHED ON THE UNDERSIDE WITH AT LEAST 1/2" GYPSUM SHEATHING OR HEAVY TIMBER CONSTRUCTION PER 602.4. VENTS ARE PERMITTED IF COVERED WITH CORROSION-RESISTANT METAL MESH


705.8: ALLOWABLE OPENINGS (SPRINKLERED BUILDINGS, UNPROTECTED OPENINGS) SETBACK/SEPARATION DISTANCE: ALLOWABLE AREA OF UNPROTECTED OPENING:

MI

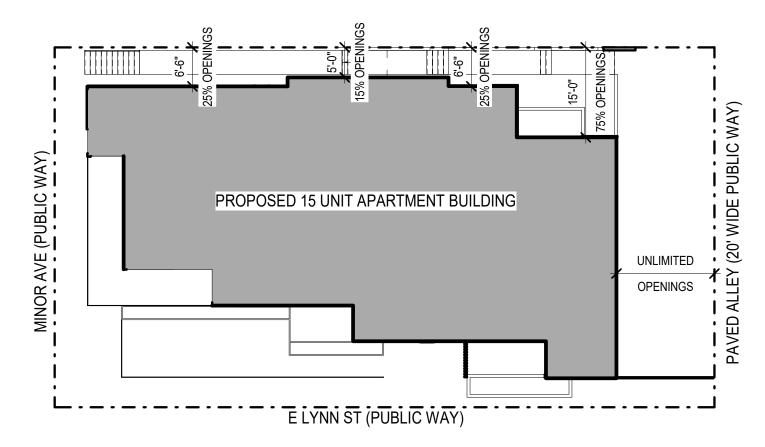

BUILDING CODE SUMMARY

CODE: 2018 SEATTLE BUILDING CODE

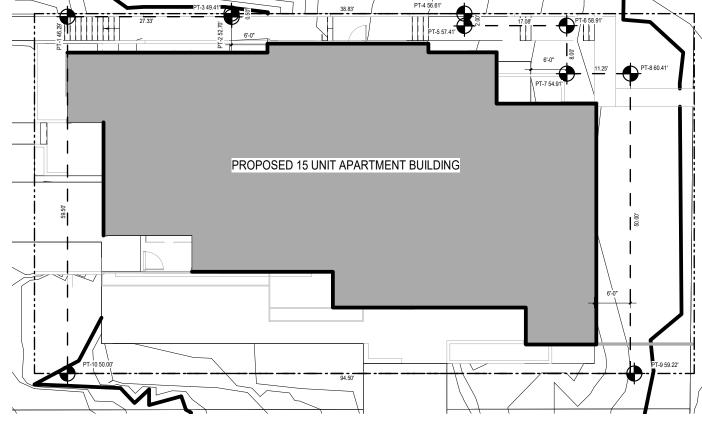

AVERAGE GRADE PLANE - SBC

	CORNER ELEVATION 1		CORNER ELEVATION 2	AVG. RUN ELEVATION	RUN LENGTH	AVG. ELEVATION X RUN LENGTH
PT-1	46.29	PT-2	52.7	52.7	27.33	1440.291
PT-2	52.7	PT-3	49.41	51.055	0.5	25.5275
PT-3	49.41	PT-4	56.61	53.01	38.83	2058.3783
PT-4	56.61	PT-5	57.41	57.01	2	114.02
PT-5	57.41	PT-6	58.91	58.16	17.08	993.3728
PT-6	58.91	PT-7	54.91	56.91	8	455.28
PT-7	54.91	PT-8	60.41	57.66	11.25	648.675
PT-8	60.41	PT-9	59.22	59.815	50	2990.75
PT-9	59.22	PT-10	50	54.61	94.5	5160.645
PT-10	50	PT-1	46.29	48.145	59.5	2864.6275
				TOTAL	308.	99 16751.5671

AVERAGE GRADE

AVERAGE GRADE

CHAPTER 3: USE AND OCCUPANCY CLASSIFICATION

302: OCCUPANCY CLASSIFICATION: RESIDENTIAL APTS: R-2 (SBC 310.4)

CHAPTER 4: SPECIAL DETAILED REQUIREMENTS BASE ON USE AND OCCUPANCY

406: MOTOR-VEHICLE-RELATED OCCUPANCIES

CLEAR HEIGHT: REQUIRED: 6'-6" MIN; PROVIDED: 8'-2" MIN FLOOR SURFACE: PARKING SURFACE IS CONCRETE

CHAPTER 5: BUILDING HEIGHT AND AREA

502.1: DEFINITIONS: GRADE PLANE:

A REFERENCE PLANE REPRESENTING THE AVERAGE OF FINISHED GROUND LEVEL ADJOINING THE BUILDING AT EXTERIOR WALLS. WHERE THE FINISHED GROUND LEVEL SLOPES AWAY FROM THE EXTERIOR WALLS. THE REFERENCE PLANE SHALL BE ESTABLISHED BY THE LOWEST POINTS WITHIN THE AREA BETWEEN THE BUILDING AND THE LOTLINE OR, WHERE THE LOT LINE IS MORE THAN 6 FEET (1829 MM) FROM THE BUILDING, BETWEEN THE BUILDING AND A POINT 6 FEET FROM THE BUILDING.

GRADE PLANE = 54.214'

502.1: DEFINITIONS: STORY ABOVE GRADE PLANE: ANY STORY HAVING ITS FINISHED FLOOR SURFACE ENTIRELY ABOVE GRADE PLANE, OR IN WHICH THE FINISHED SURFACE OF THE NEXT FLOOR ABOVE IS MORE THAN 12 FT ABOVE THE

FINISHED GROUND LEVEL FOR MORE THAN 25 FT OF THE PERIMETER

LOWEST FINISHED GRADE AT P1 TO FINISHED SURFACE OF L1 IS 10'-6". P1 IS THEREFORE NOT CONSIDERED A STORY ABOVE GRADE PLANE. SEE DEFINITIONS: BASEMENT.

502.1: DEFINITIONS: BASEMENT:


OCCUPANCY: R-2

504/506: ALLOWABLE HEIGHT AND AREA: -BASE TABULAR VALUES FROM TABLE 504.3, 504.4, & 506.2

A STORY THAT IS NOT A STORY ABOVE GRADE PLANE.

HEIGHT STORIES 5 STORIES AREA 36,000 SF/STORY

Johnston Architects, LLC 100 NE Northlake Way, Suite 200 Seattle, WA 98105 t 206.523.6150 f 206.523.9382

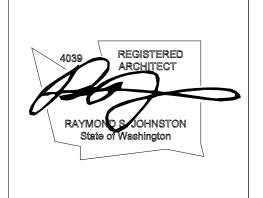

Z Z DRAWING ISSUE

16785.16715 SF

OR 54.214'

54.2139457587624

2021.11.23 MUP INTAKE

DESCRIPTION

SHEET TITLE

SHEET NO.

Checked © 2019 JOHNSTON ARCHITECTS

A PORTION OF THE SE 1/4 OF THE NW 1/4 OF GRAPHIC SCALE SECTION 20, TOWNSHIP 25 NORTH, RANGE 4 EAST, W.M. CITY OF SEATTLE, STATE OF WASHINGTON (IN FEET) FOUND 2" BRASS DISK 1 inch = 20 ft.IN CONCRETE IN CASE SURVEY NOTES MON IS 5.35 OFFSET MON AT THE INTER. E LOUISA ST INSTRUMENT: SPECTRA FOCUS 35 TOTAL STATION & MINOR AVE E METHOD USED: FIELD TRAVERSE WITH ACTUAL (11/16)FIELD MEASUREMENTS AND ANGLES WAC 332-130-090 DATE OF SURVEY: NOVEMBER 2016 BASIS OF BEARING: E LYNN STREET (N89°55'42"E) FOUND LEAD AND BENCHMARK: CITY OF SEATTLE BM#3763-4002 SCREW OFFSET (11/16) 37.5 37.5 2" BRASS DISK STAMPED "3763-4002" LOCATED AT THE INTERSECTION OF FAIRVIEW AVE E & E LYNN STREET ON THE SOUTH SIDE OF TOPO STEPS. 1.0' OF RETAINING WALL TO PARK 11 \$290220-1179 FOUND LEAD & TACK W/SHINNER 10' OFFSET TO CORNER MINOR AVE E AND E LYNN STREET ELEVATION = 44.83' (NAVD88)REFERENCE SURVEY: CITY OF SEATTLE SHORT PLAT #3017116 PER SSCARD 20.00' GAS KING COUNTY REC#20140808900003 EX BUILDING TAX PARCEL # 290220-1170 EX BUILDING FOUND LEAD AND SITE ADDRESS: 78 E LYNN STREET SCREW OFFSET (11/16) CONC WALK SEATTLE, WA 98102 S89°55'42"W CONC WALK !!!!! LEGAL DESCRIPTION LOT 26, BLOCK 14 OF GREEN'S ADDITION TO THE CITY OF SEATTLE, AS PER PLAT RECORDED IN VOLUME 2 OF PLATS, PAGE 73, RECORDS OF KING COUNTY AUDITOR \triangleleft EAVES -SITUATE IN THE CITY OF SEATTLE, COUNTY OF KING, STATE OF GARAGE FF=48.1' EX APARTMENT BUILDING MINOR WASHINGTON. PER SSCARD LEGEND TL#290220-1175 EX BUILDING FF=56.7' CB (TYPE 1) TELEPHONE VAULT – FF=56.7 FF=60.0' ☐ STMH (TYPE 11) TELEPHONE CABINET FF=60.0' (S) SANITARY SEWER MH SIGN EX STMH <u>CONC</u> 20.00 CONIFER TREE RIM EL = 45.12'1017777 ⋈ WATER VALVE INV EL = 42.12'-8"W10' OFFSET DECIDUOUS TREE ■ WATER METER/SERVICE () INV EL = 42.42'-6"E58.00 58.70 58.70 58.70 - FIRE HYDRANT MONITORING WELL -O- UTILITY POLE MAIL BOX CONC WALK ← GUY WIRE 30 PK NAIL SIGNAL CABINET MON IN CASE/ SSMH POWER JUNCTION BOX RIM EL = 44.11'EX REBAR / PIPE X LIGHT POLE AS NOTED INV EL =31.90-36" D GAS VALVE 147.54' (C) 307.58\(ROS)(M) N89°55'42"È STREE FOUND PIN IN CONCRETE IN CASE AT THE INTER OF YALE AVE E & E LYNN STREET (1116) EX STMH RIM EL = 45.1337.5 - RIM EL = 45.43'INV EL = 41.63'-8"WINV EL = 44.53'-6"WINV EL = 42.10'-6"EFOUNDS 2" BRA\$S DISK └ IN CONCRETE IN CASE EX CB (11/16)- RIM EL = 45.52'INV EL = 44.62'-6"WRECORDER'S CERTIFICATE No. ___ LAND SURVEYOR'S CERTIFICATE BOUNDARY AND TOPOGRAPHY 78 EAST LYNN STREET Filed for record this ___day of_____,20__ at____ This map correctly represents a survey made by me or under my direction in conformance

with the requirements of the Survey Recording

in book___of__at page____at the request

Mgr.

Supt. of Records

Act at the request of

Certificate No. 38992


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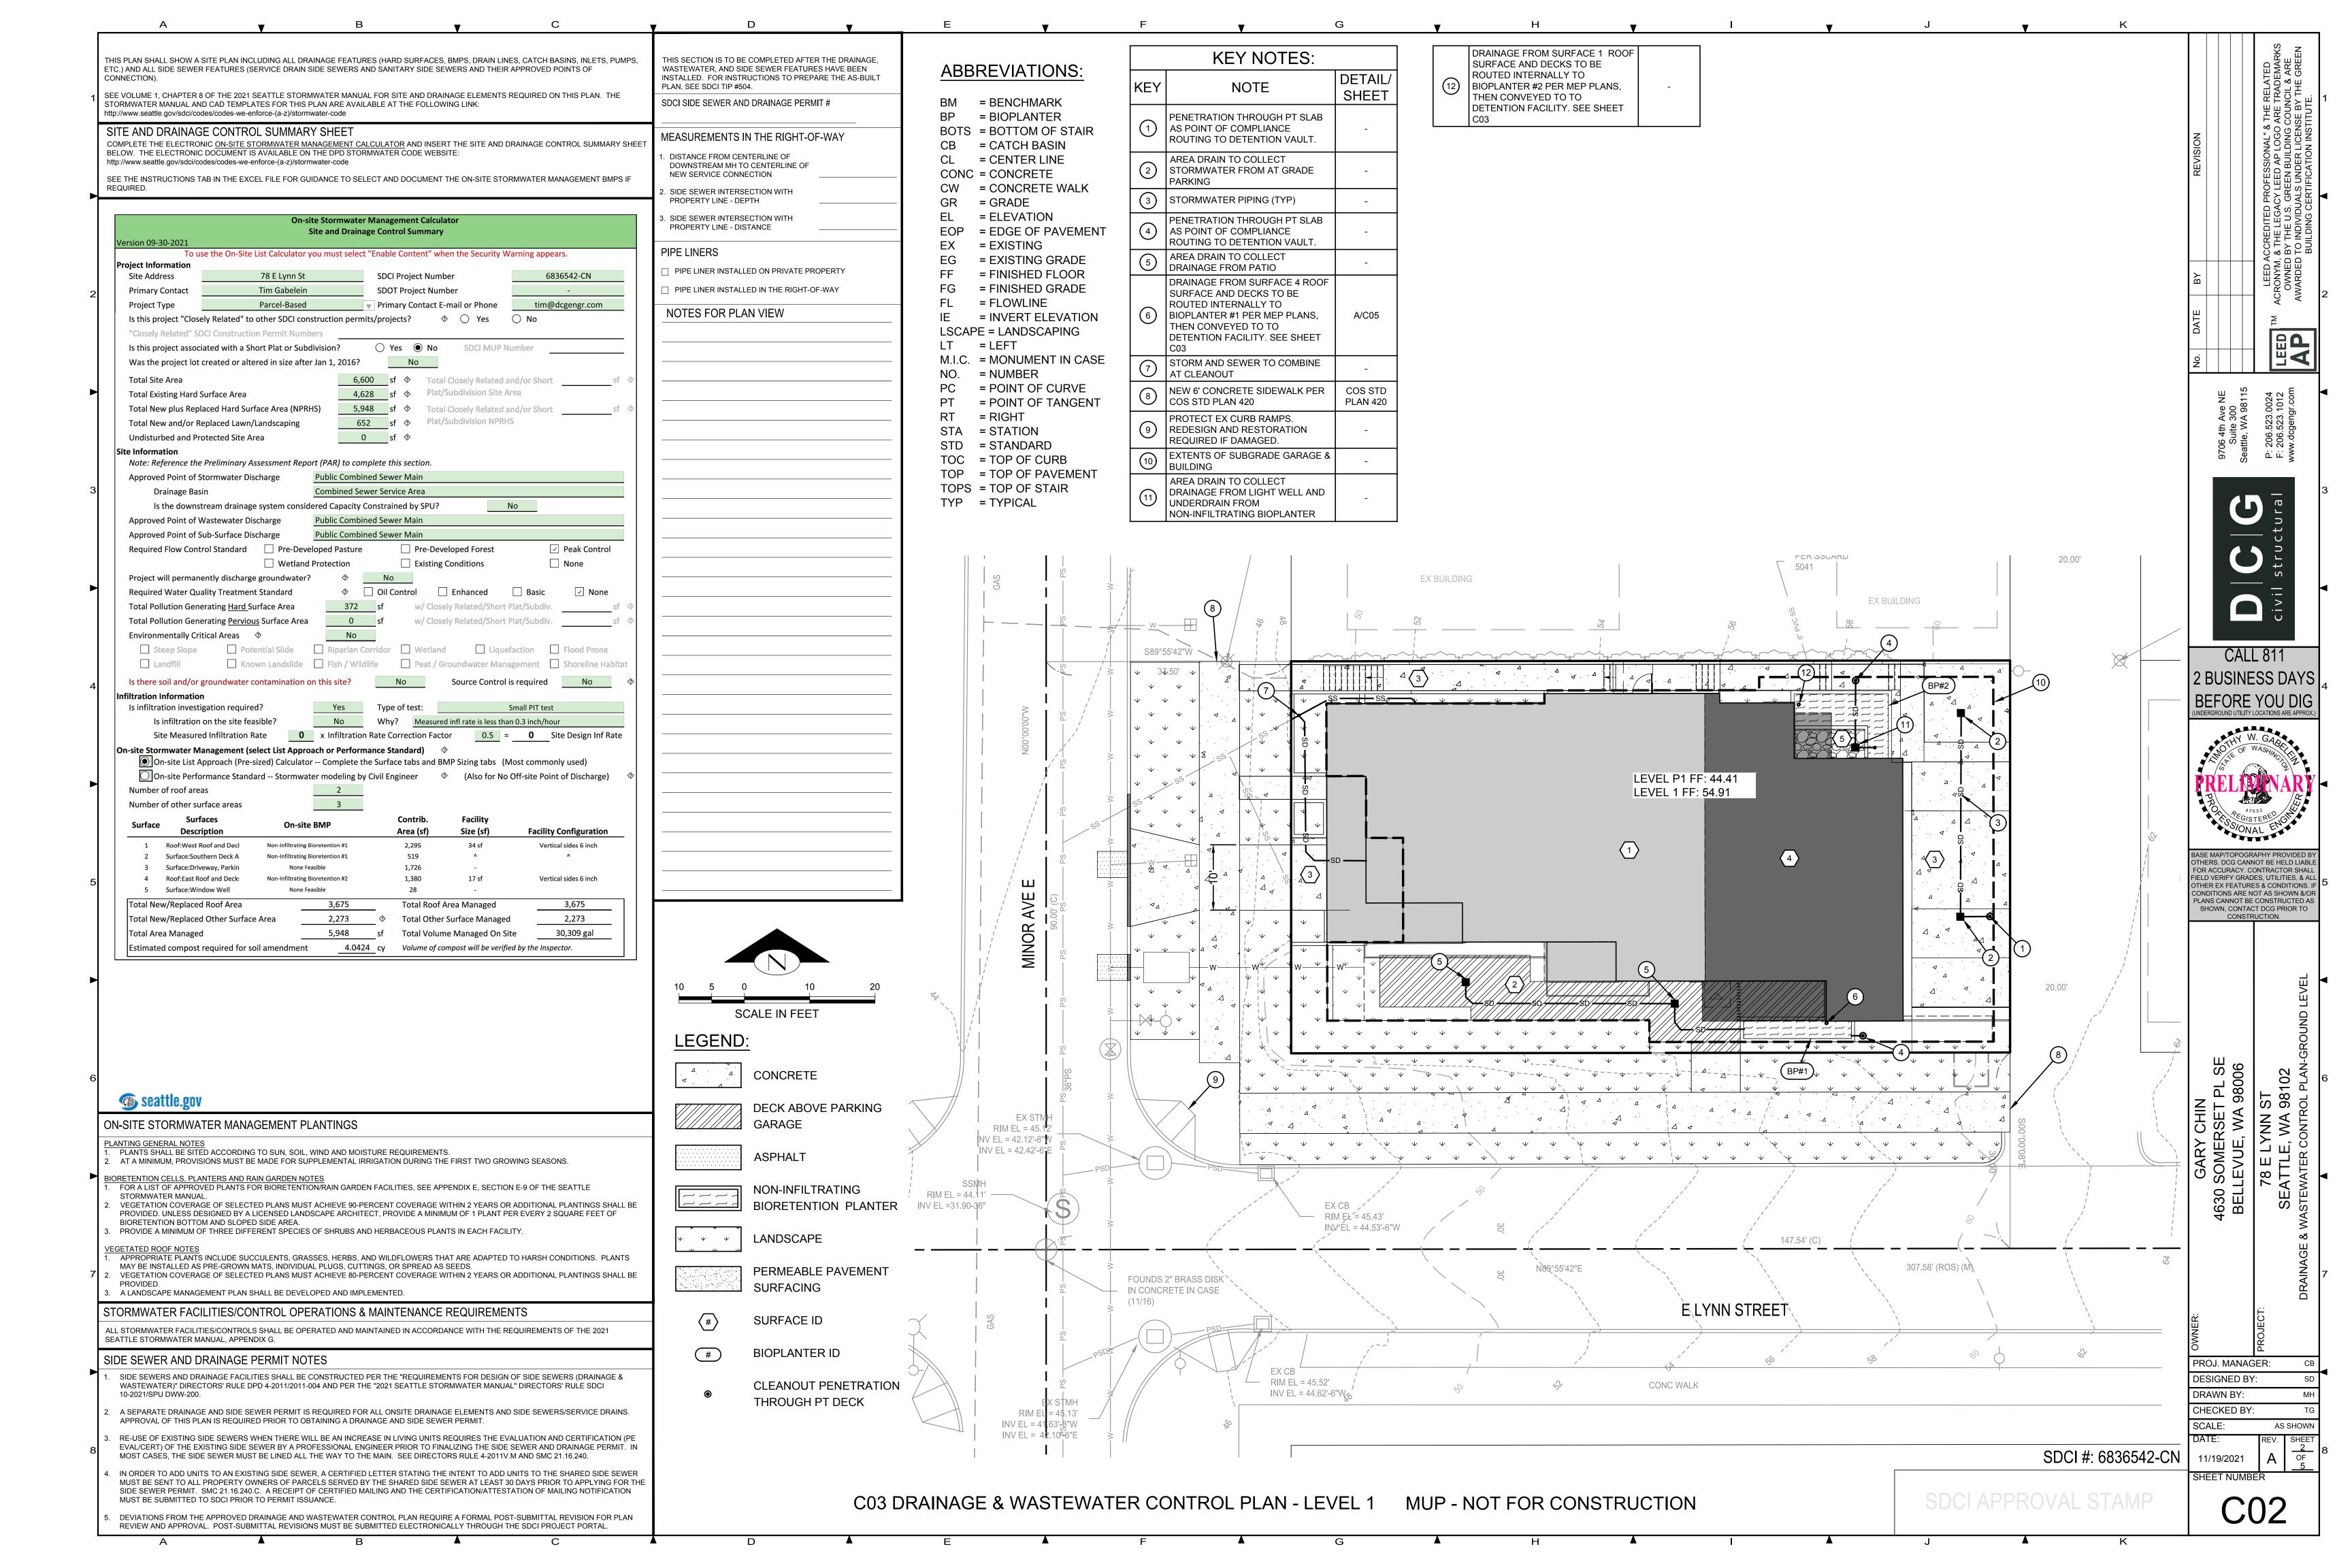
TOUMA ENGINEERS AND LAND SURVEYORS, PLLC


255 SW 41st STREET RENTON, WASHINGTON 98057 425-251-0665 OFFICE 425-251-0625 FAX


SEATTLE, WA 98102


DWN. BY DAN T	DATE NOVEMBER 2016	JOB NO. 1024-003B-016
DAN I	NOVEMBER 2016	1024-0036-016
CHKD. BY	SCALE	SHEET
MHT	1"= 20'	1 OF 1




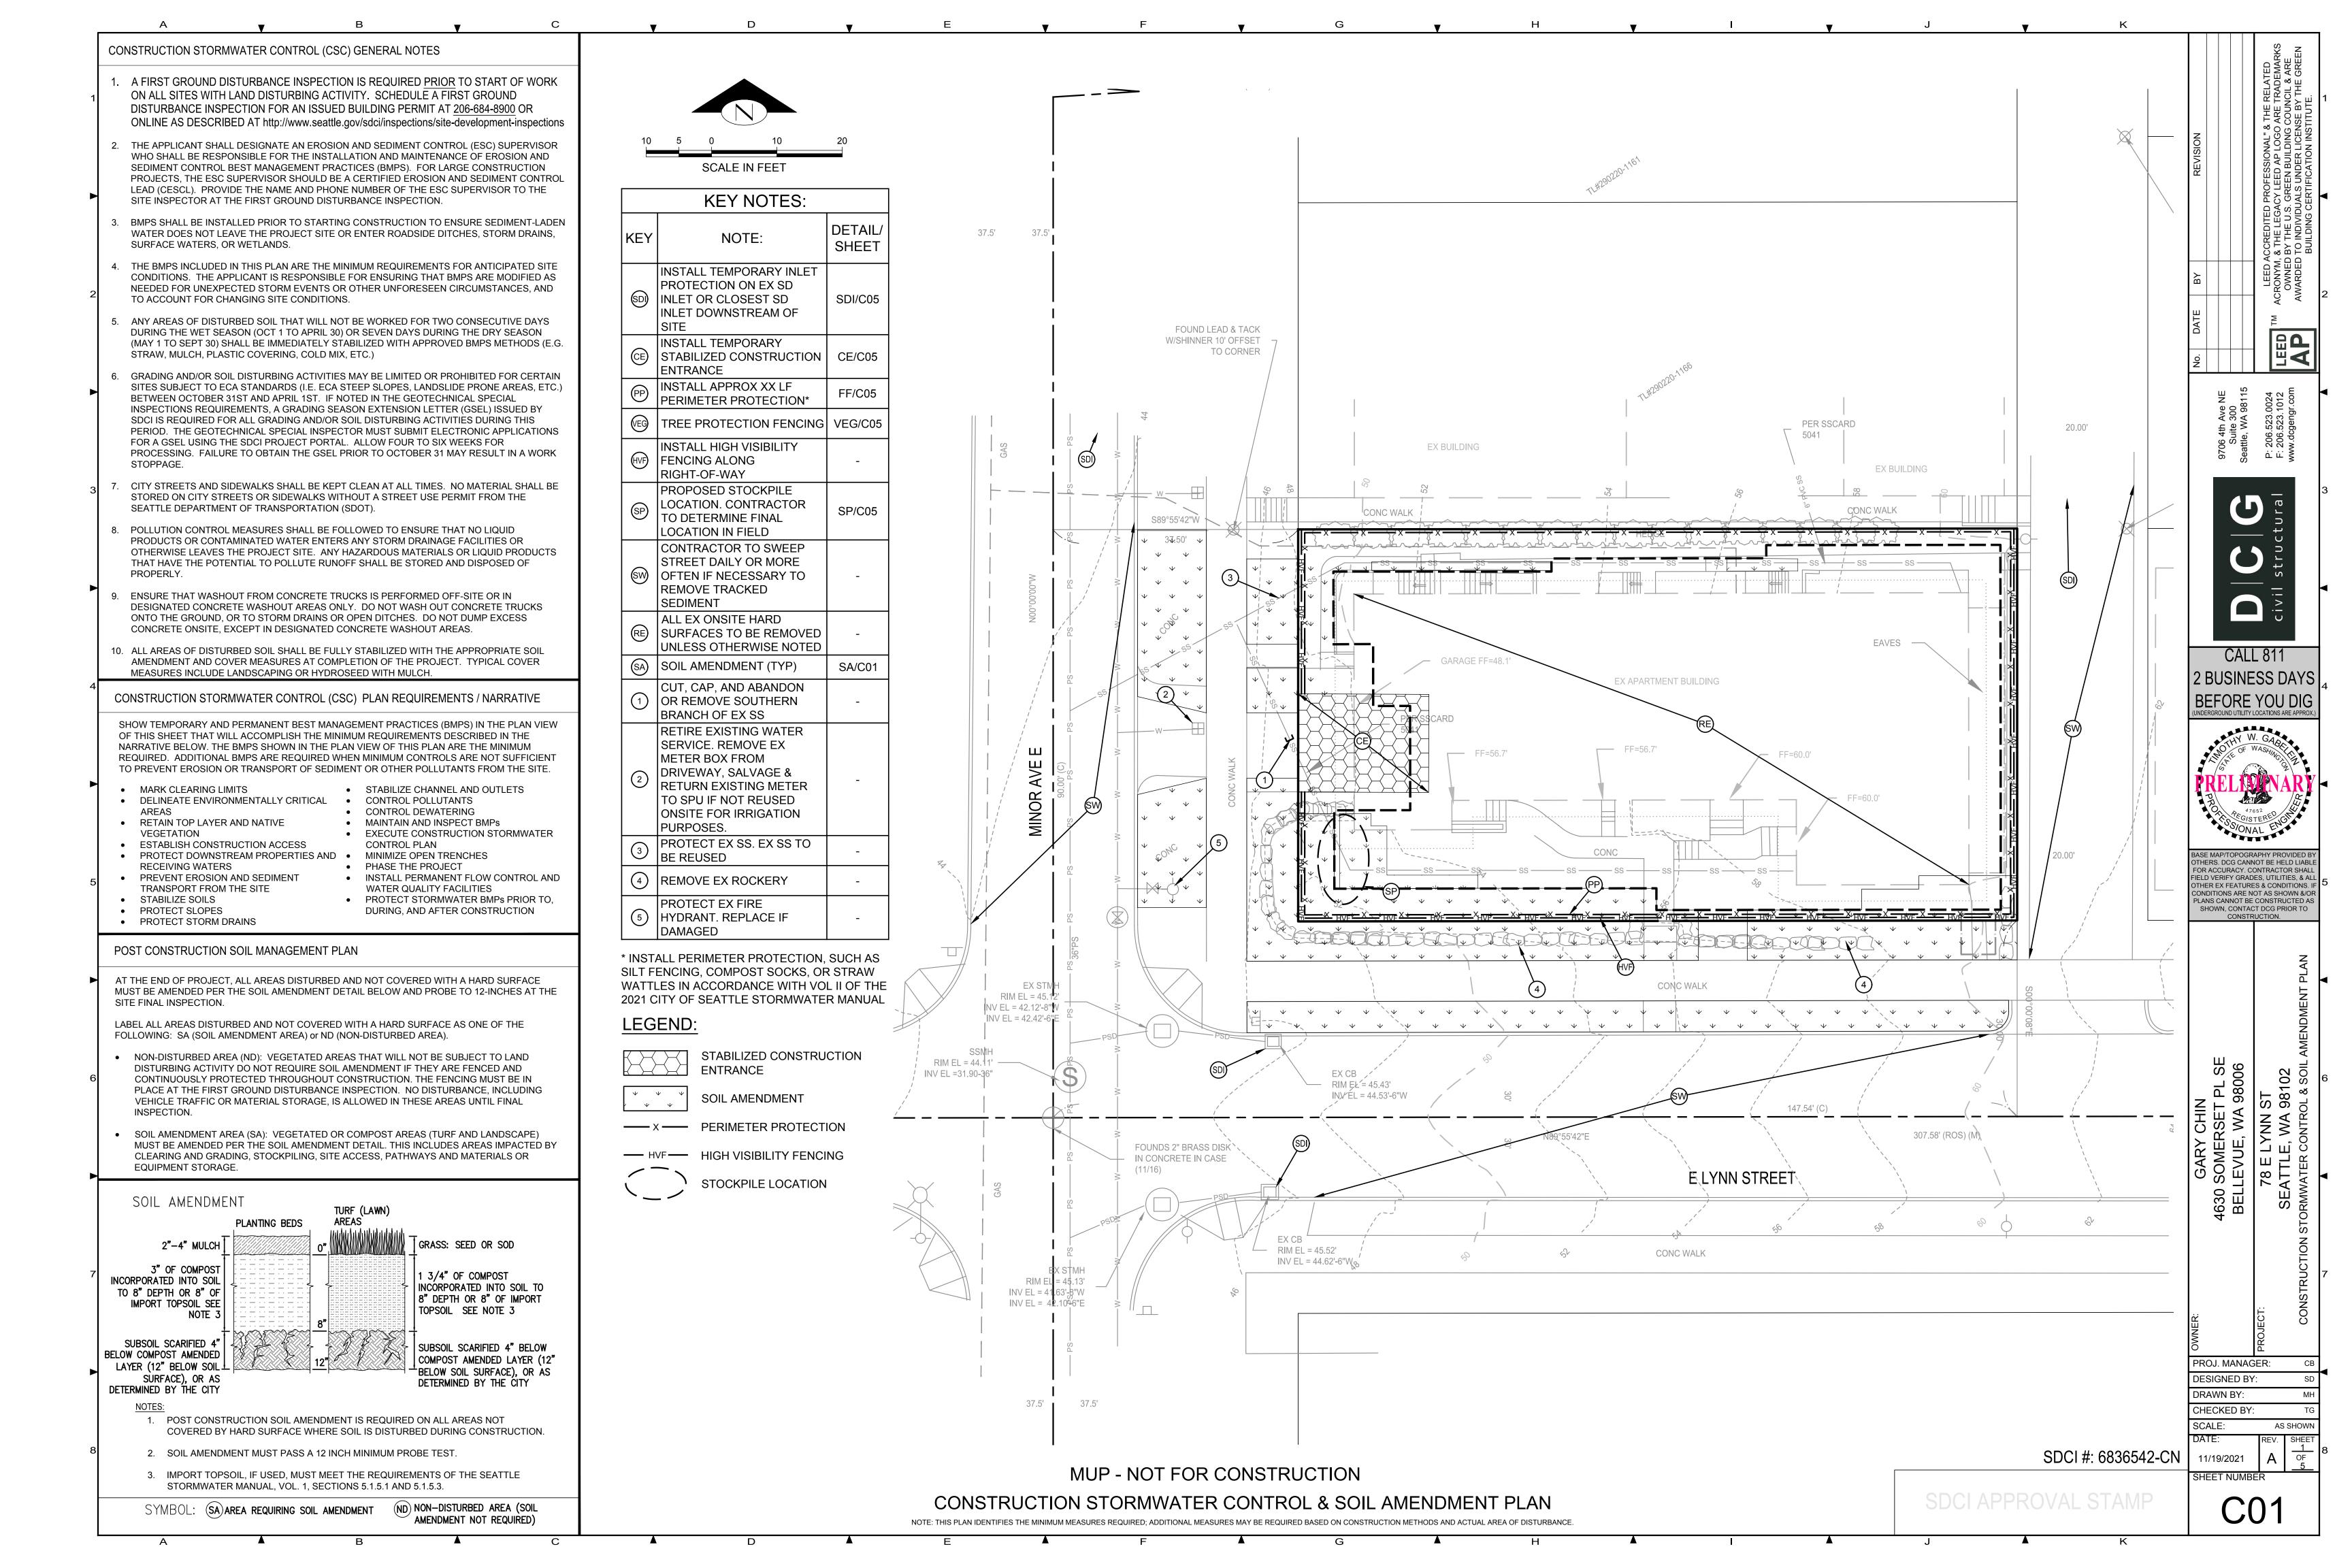

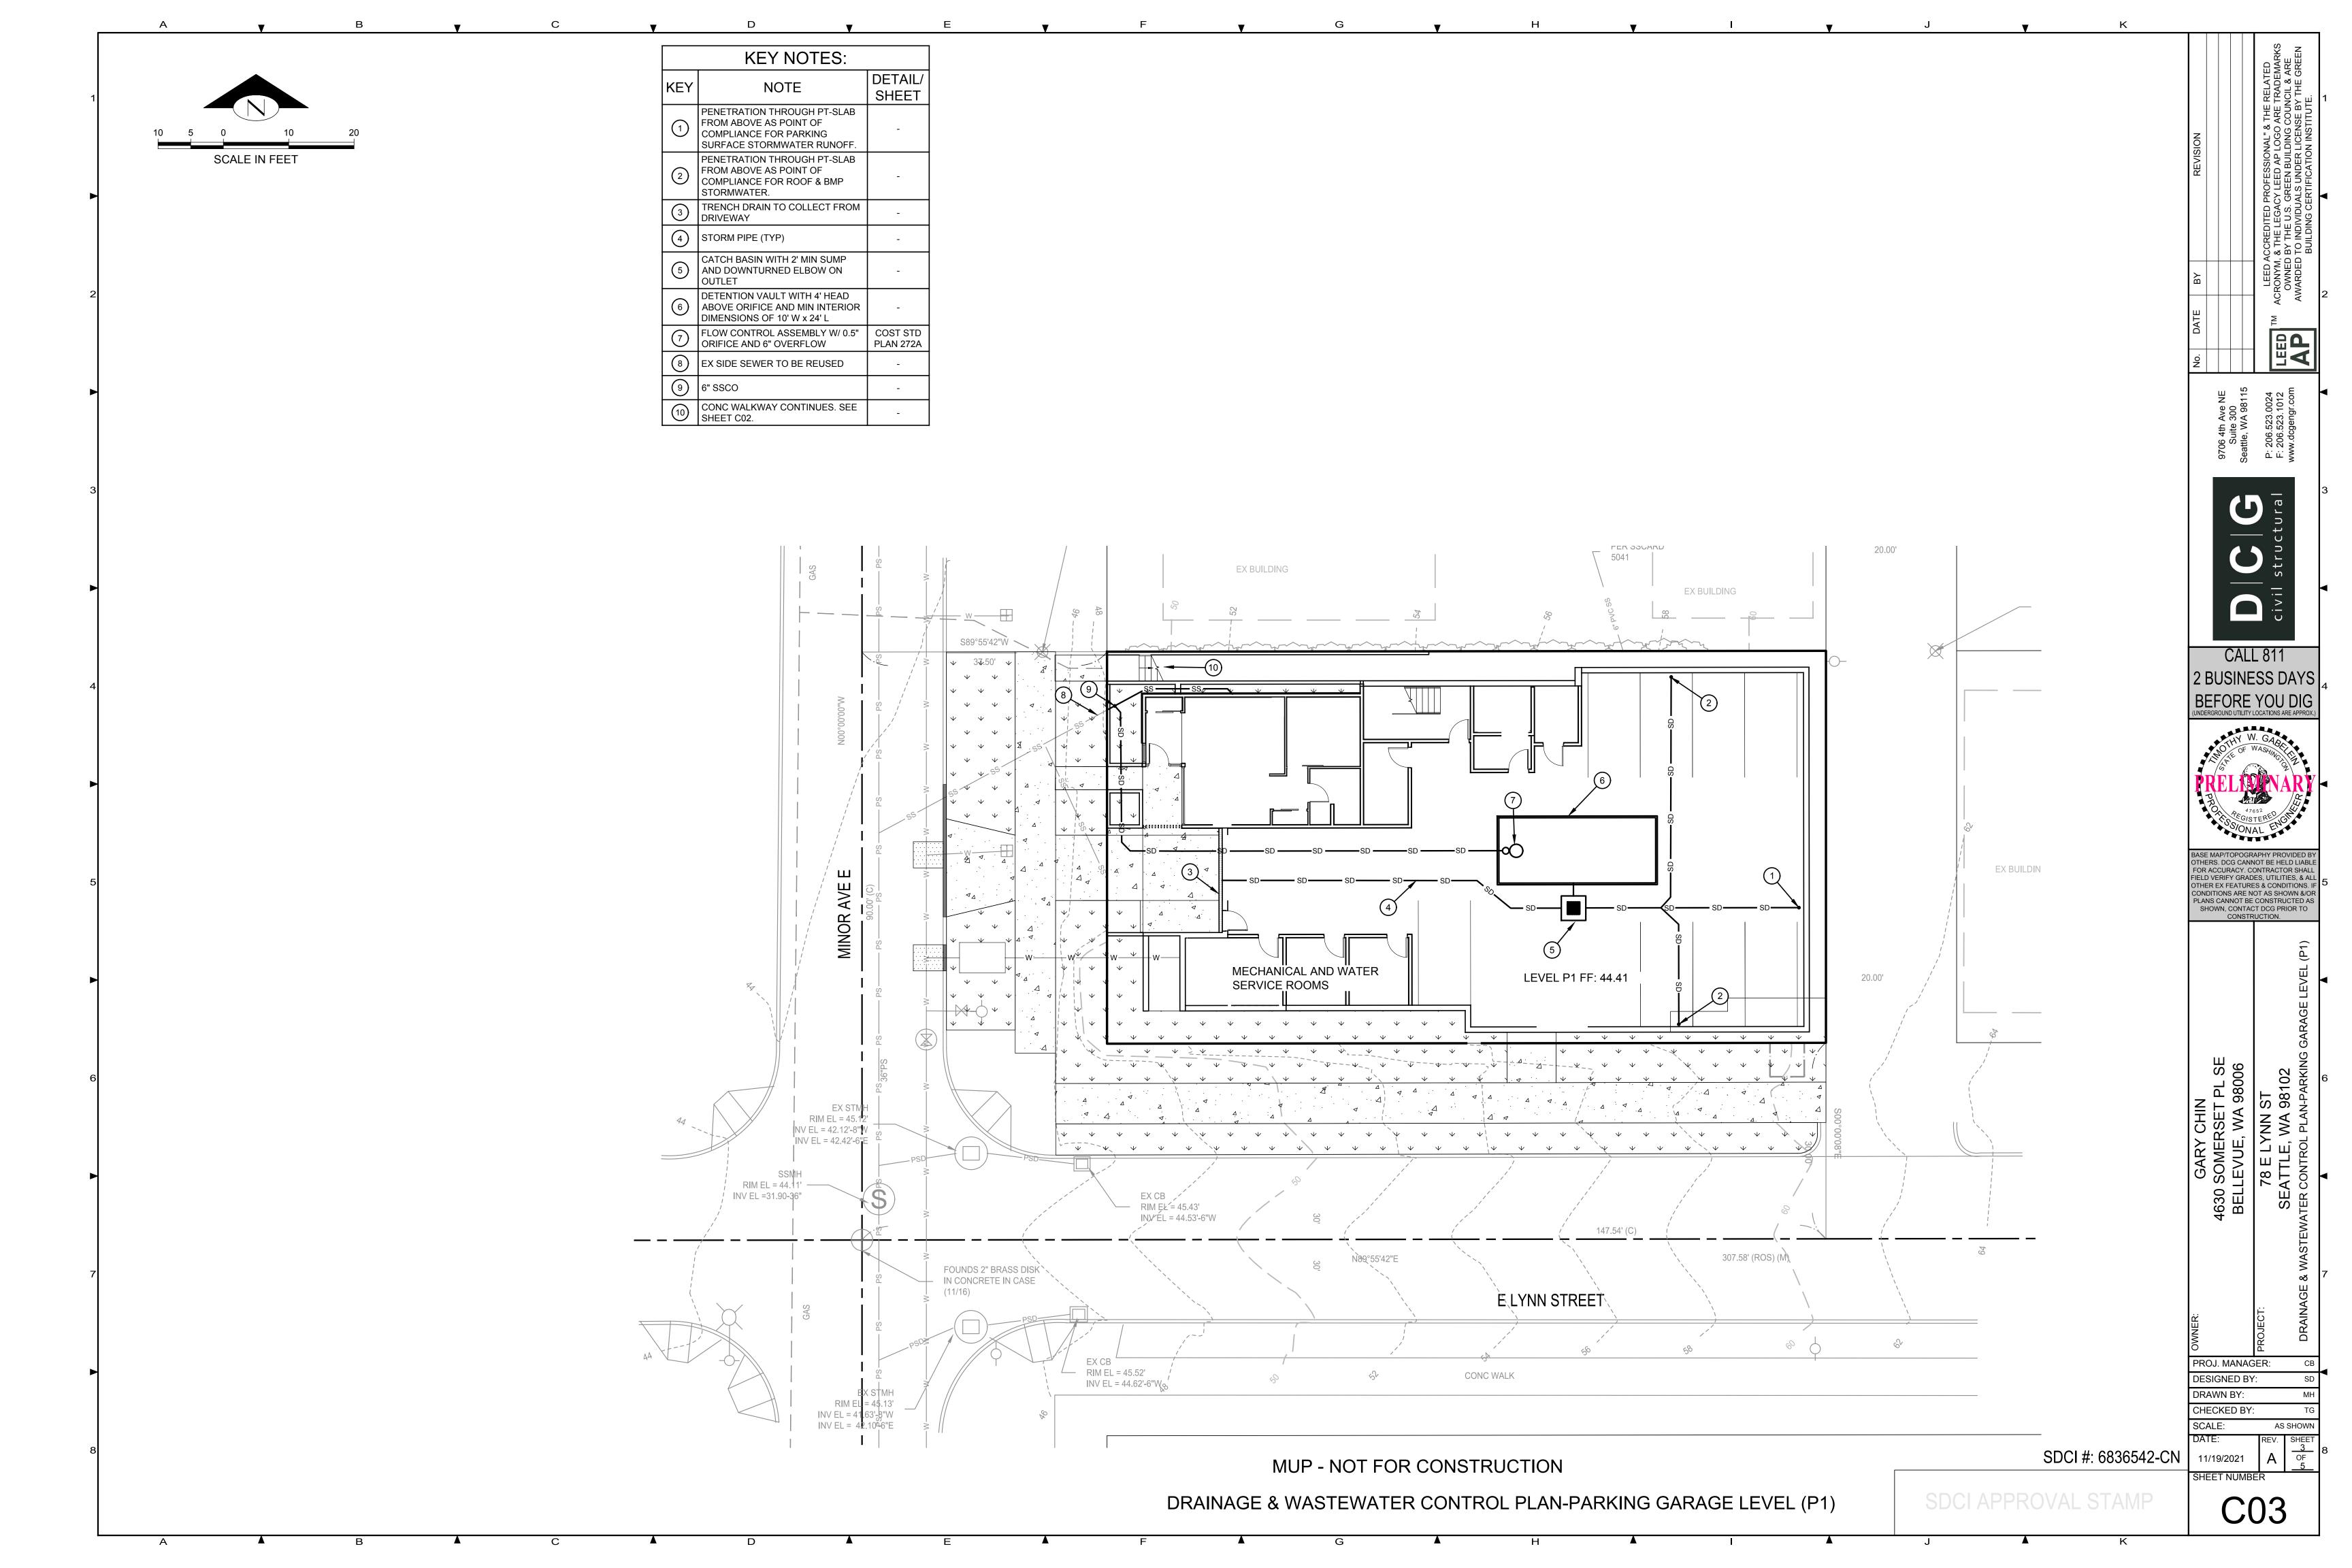

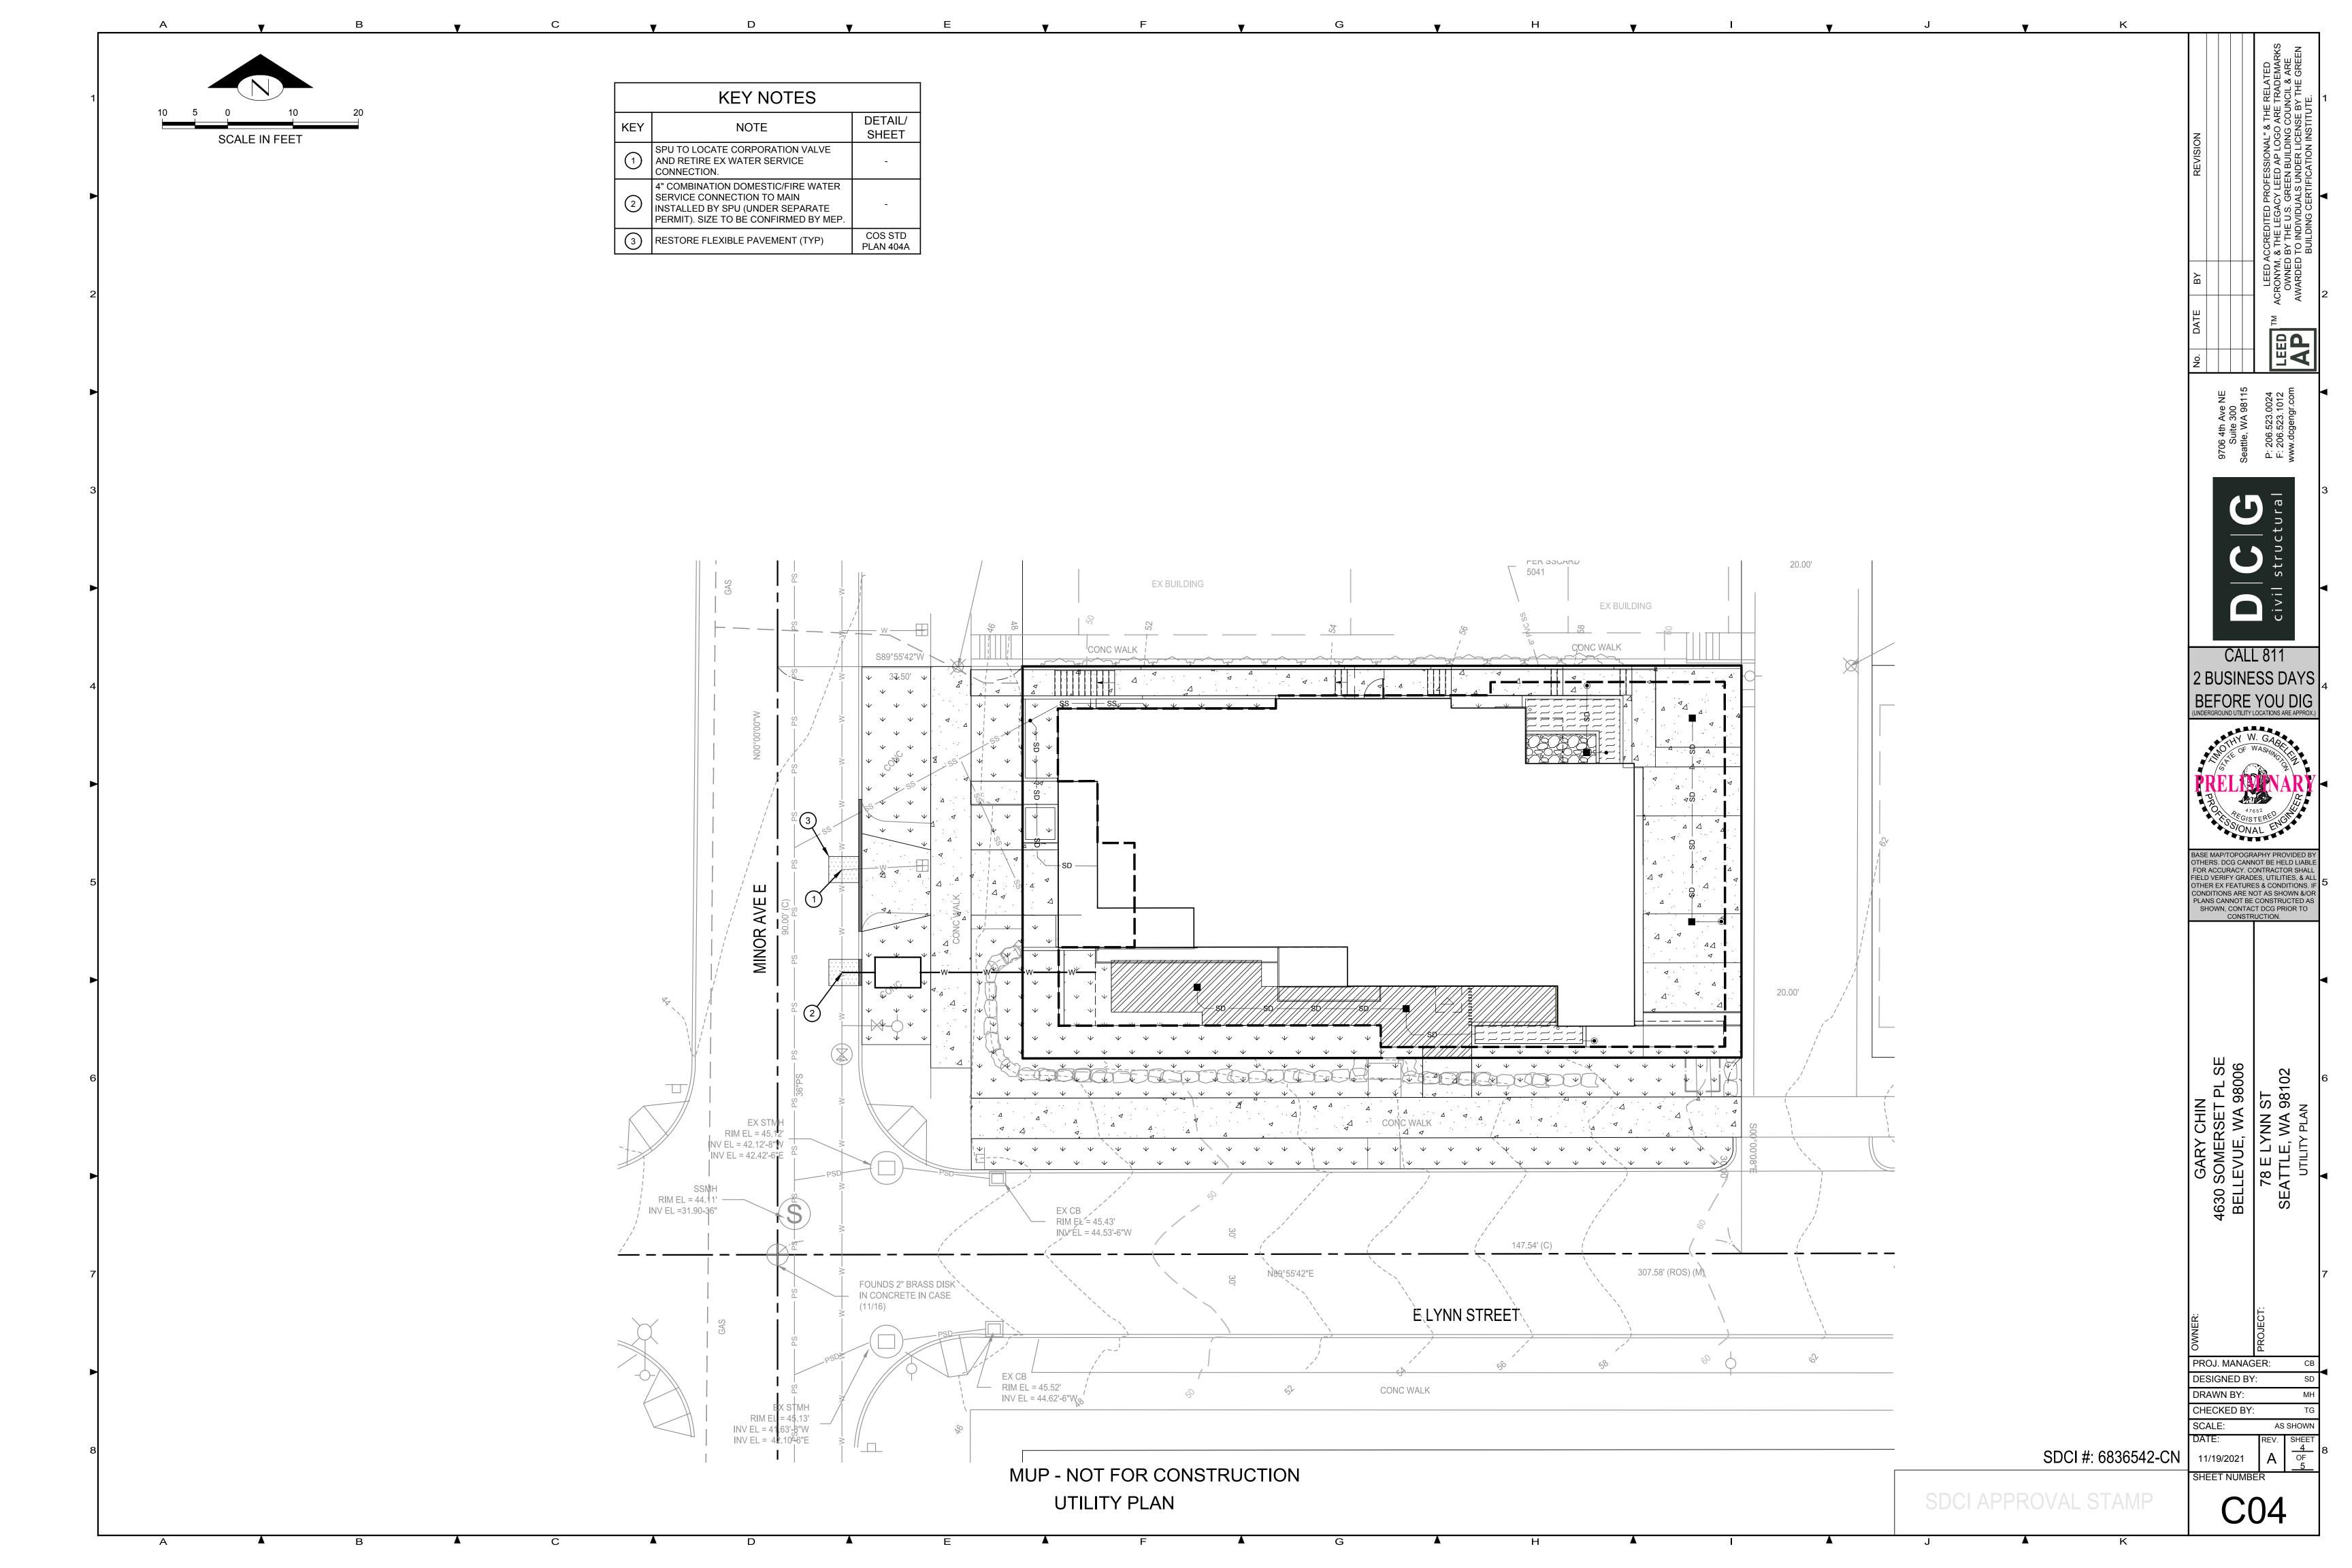

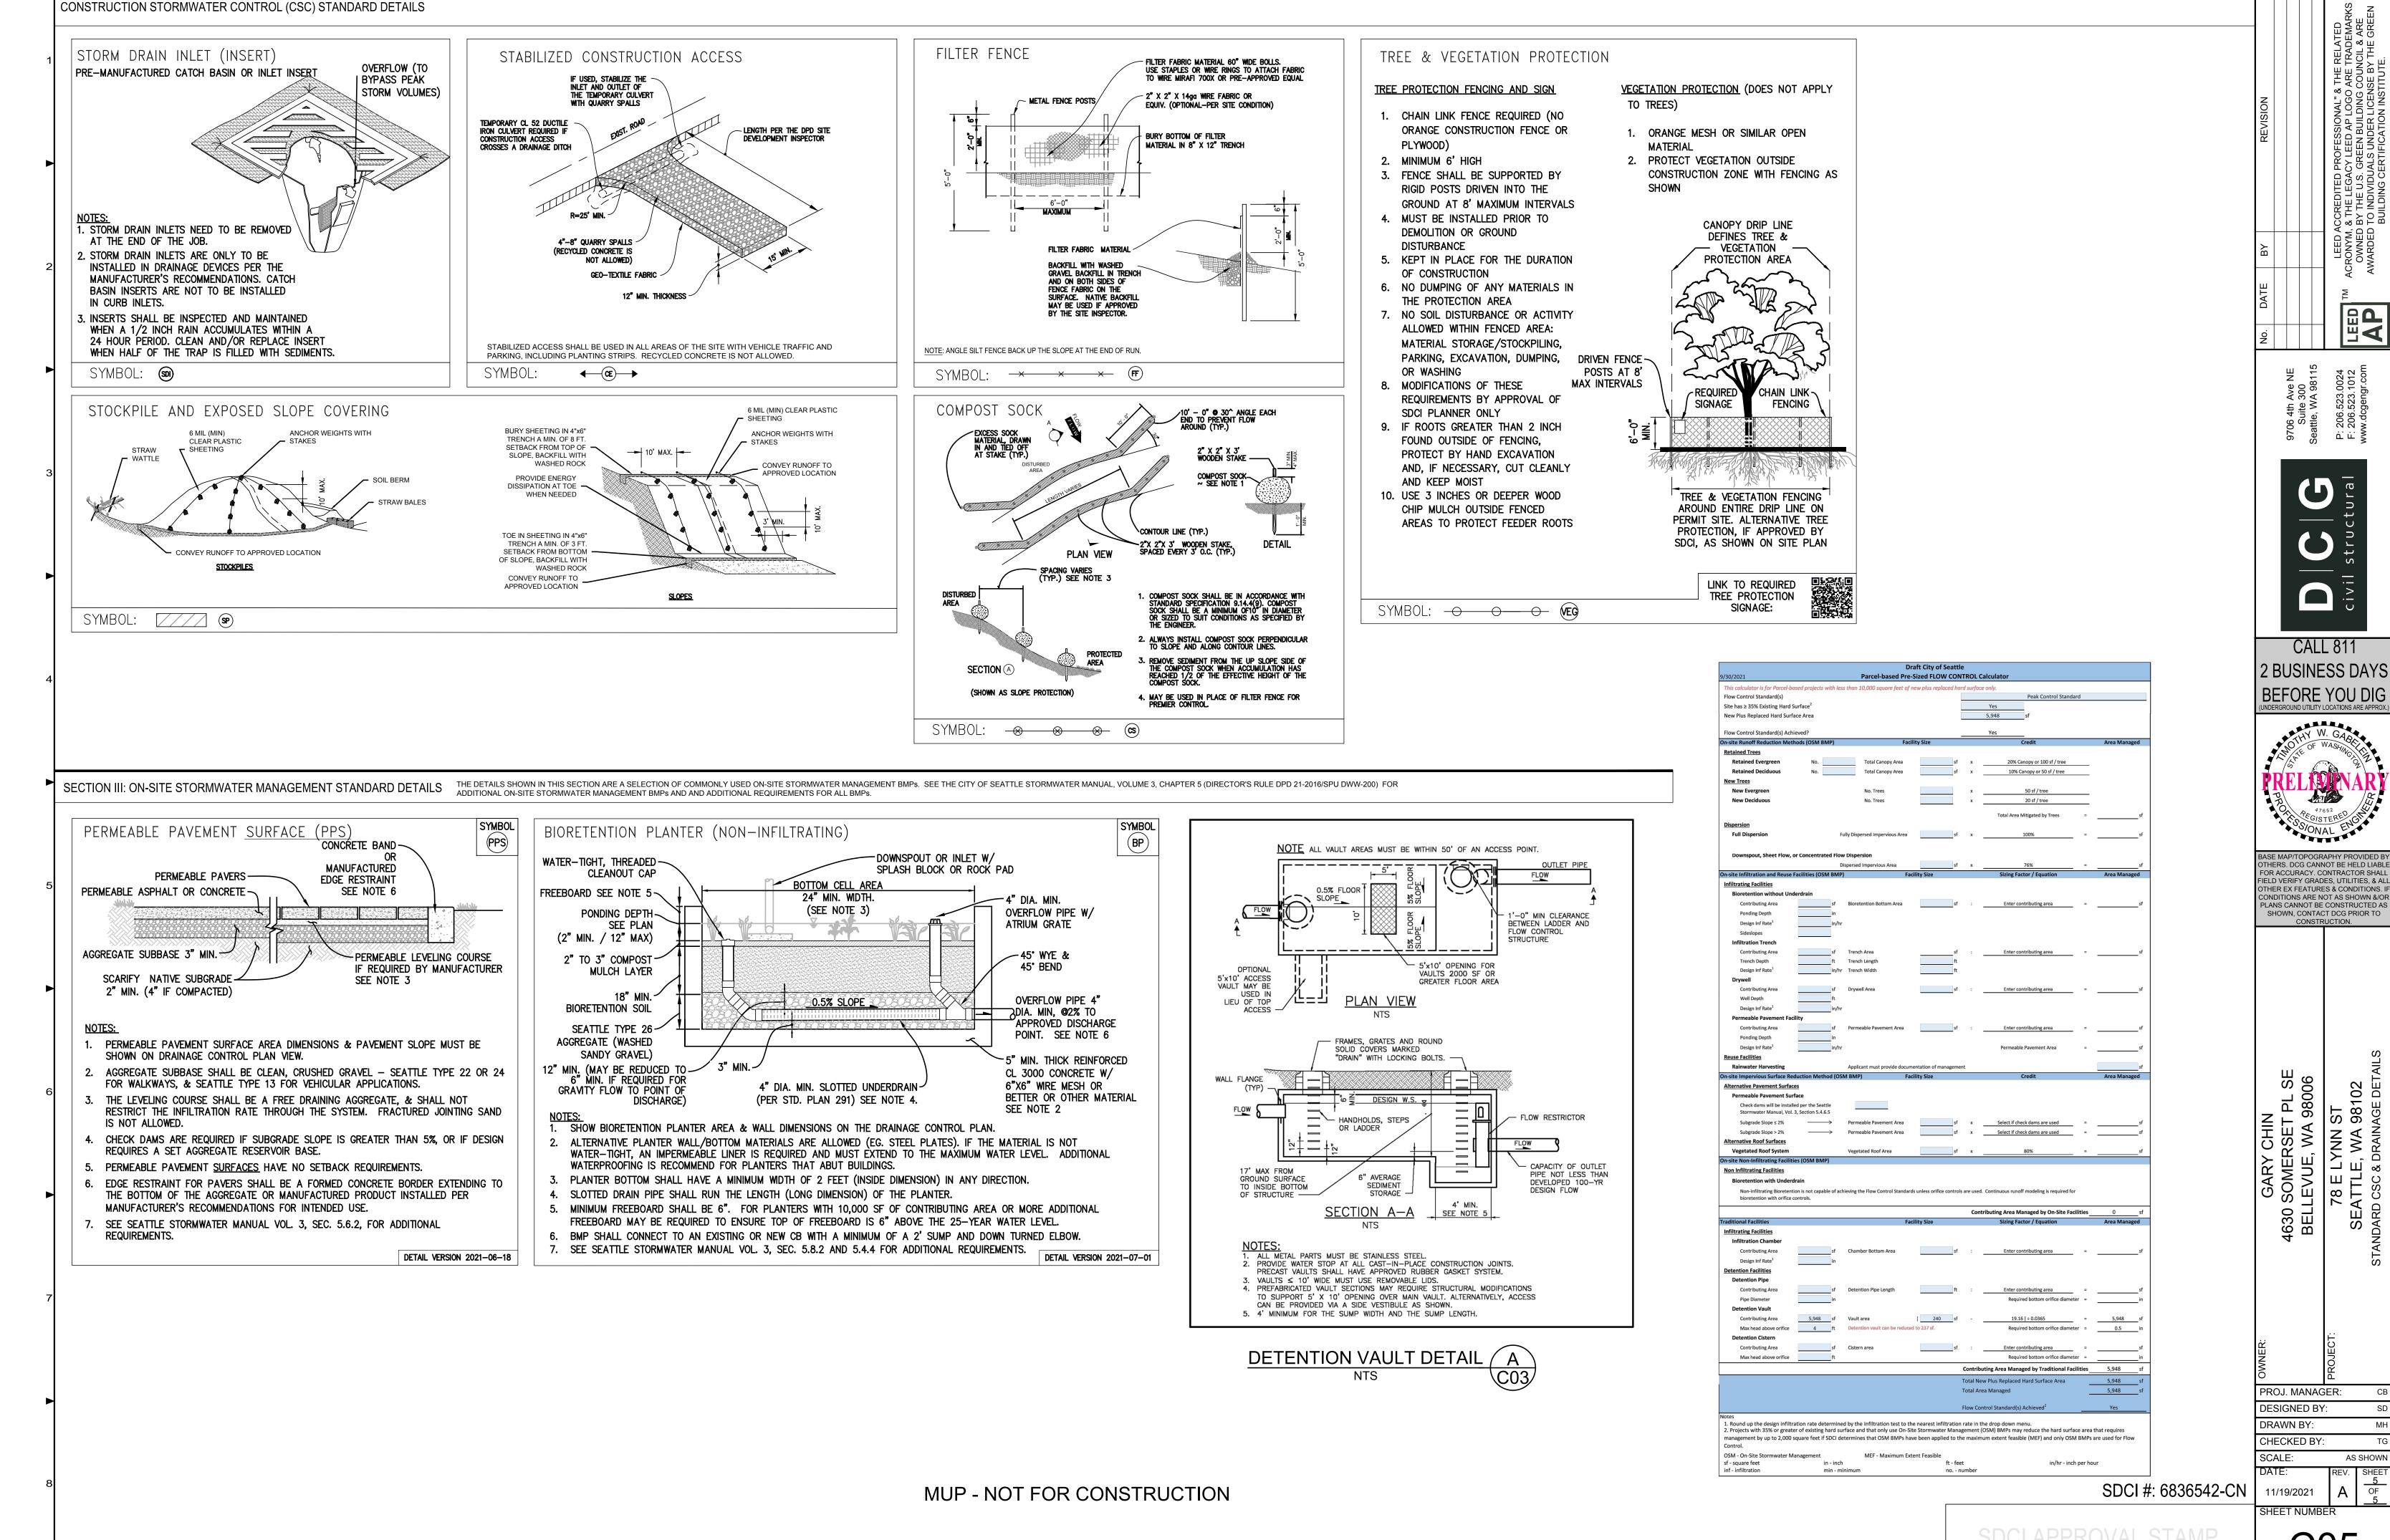

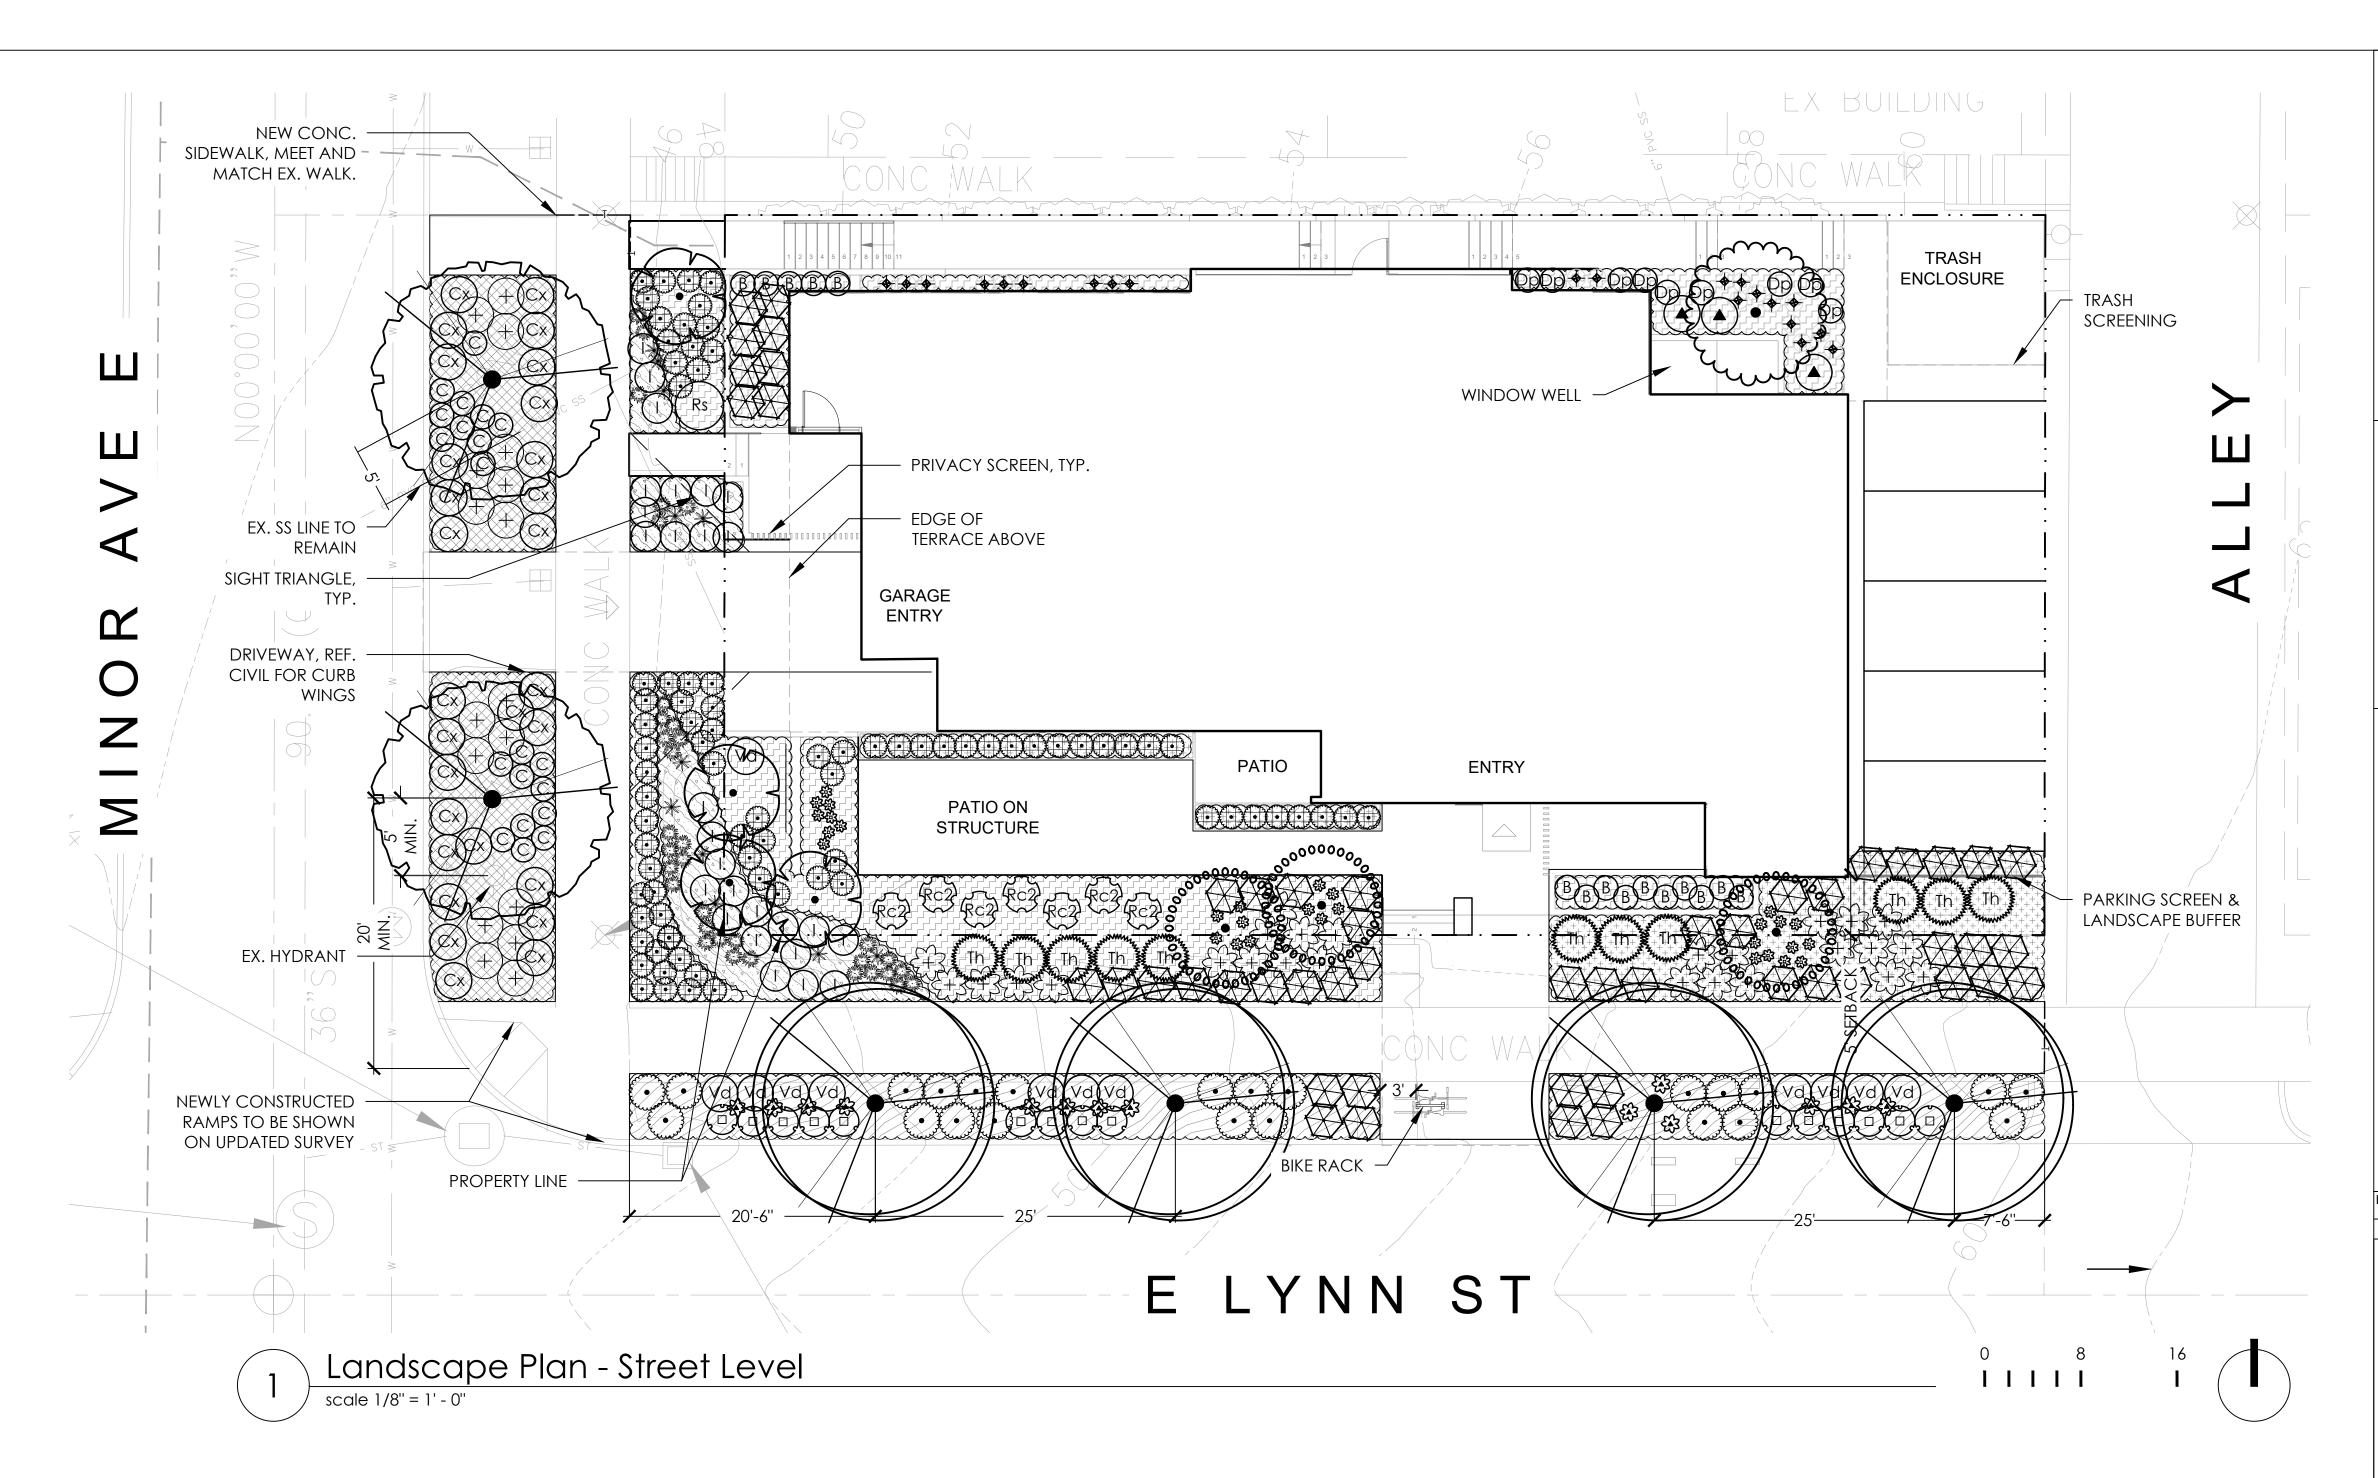

RIGHT-OF-WAY PLANTING AREAS: (PER COS STD PLAN 142)

- ALL SOIL AREAS DISTURBED OR COMPACTED DURING CONSTRUCTION, AND NOT COVERED BY BUILDINGS OR PAVEMENT, SHALL BE AMENDED WITH COMPOST AS DESCRIBED BELOW.
- 2. SUBSOIL SHOULD BE SCARIFIED (LOOSENED) 4 INCHES BELOW AMENDED LAYER, TO PRODUCE 12-INCH DEPTH OF UN-COMPACTED SOIL, EXCEPT WHERE SCARIFICATION WOULD DAMAGE TREE ROOTS OR AS DETERMINED BY THE ENGINEER.
- COMPOST SHALL BE TILLED IN TO 8 INCH DEPTH INTO EXISTING SOIL OR PLACE 8 INCHES OF COMPOST-AMENDED SOIL PER SOIL SPECIFICATION.
- 4. PLANTING BEDS SHALL RECEIVE 3" OF COMPOST TILLED INTO 8" DEPTH, OR MAY SUBSTITUTE 8" OF IMPORTED SOIL CONTAINING 35-40% COMPOST BY VOLUME. MULCH AFTER PLANTING WITH 2-4 INCHES OF ARBORIST WOOD—CHIP MULCH OR APPROVED EQUAL. MULCH PER BELOW.
- 5. SETBACKS: TO PREVENT UNEVEN SETTLING, DO NOT COMPOST-AMEND SOILS WITHIN 3 FEET OF UTILITY INFRASTRUCTURES (POLES, VAULTS, METERS, ETC.). WITHIN ONE FOOT OF PAVEMENT EDGE, CURBS AND SIDEWALKS SOIL SHOULD BE COMPACTED TO APPROXIMATELY 90% PROCTOR TO ENSURE A FIRM SURFACE.
- 6. REFER TO CITY OF SEATTLE STANDARD SPECIFICATIONS: 8-02 TOPSOIL TYPE B.
 - 9-14.1 TOPSOIL TYPE A IMPORTED, TOPSOIL TYPE B REUSED AMENDED SITE SOIL AND PLANTING SOIL.

ON-GRADE TOPSOIL:

- 1. TOPSOIL: TWO-WAY MIX, AVAILABLE AT CEDAR GROVE COMPOSTING, MAPLE VALLEY, WA, (877) 764-5748, OR APPROVED
- 2. PREPARATION: LOOSEN SUBGRADE SOIL TO MINIMUM DEPTH OF 8 INCHES W/CULTIMULCHER OR SIMILAR EQUIPMENT. REMOVE STONES, GRAVEL, STICKS, ETC.
- 3. PLACEMENT: TOPSOIL MINIMUM DEPTH 8". SPREAD APPROX. 1/2 THE THICKNESS OF PLANTING SOIL MIX OVER LOOSENED SUBGRADE. MIX THOROUGHLY INTO TOP 4-INCHES OF SUBGRADE. SPREAD REMAINDER TO MEET REQUIRED GRADES. HOLD 3" BELOW ADJACENT PAVED WALKS, CURBS, AND PLANTER WALLS.

MULCH:

1. BARK MULCH: PACIFIC GARDEN MULCH, CEDAR GROVE COMPOST, OR APPROVED EQUAL, AND SHALL BE NO LESS THAN 2 OR MORE THAN 4 YEARS OLD. MINIMUM DEPTH 2", EXCEPT WHERE NOTED OTHERWISE.

LANDSCAPE NOTES:

- 1. PROJECT MEETS 0.60 SEATTLE GREEN FACTOR SCORE.
- ALL PROPOSED PLANTING AREAS SHALL BE WATERED FOR PLANT ESTABLISHMENT, WITH EXCEPTION OF MULCH BEDS AT EXISTING TREES.
- 3. SEE COS STD PLANS 100 SERIES FOR ADDITIONAL PLANTING REQUIREMENTS AND DETAILS.

Karen Kiest Landscape Architects 111 west john street suite 306 seattle washington 98119



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11.23.2021 MUP INTAKE

SHEET TITLE

LANDSCAPE PLAN

SHEET NO.

L100

<u>TREES</u>	BOTANICAL NAME	COMMON NAME	SIZE	COND	<u>SHRUBS</u>	BOTANICAL NAME	COMMON NAME	SIZE	COND DROUGHT	<u>SPACING</u>	Kies
~~~					B	BUXUS MICROPHYLLA 'WINTER GEM'	GLOBE WINTER GEM BOXWOOD	5 GAL.	CONT.	24" o.c.	l ē.
					Cx	CISTUS X HYBRIDUS	WHITE ROCKROSE	5 GAL.	CONT.	36" o.c.	∑ ×
	STREET TREES - MINOR AVE E CONCEPTUAL APPROVAL I	BY SDOT URBAN FORESTRY 11/19/2021, REG	CORD NUMBER:		©	CORNUS SERICEA `KELSEYI`	KELSEYI DOGWOOD	2 GAL.	CONT.	24" o.c.	
// 5	SDOT TREE0002808.					DISTYLIUM X 'PIIDIST-V' TM	CINNAMON GIRL DISTYLIUM	2 GAL.	CONT.	24" o.c.	
4r_~~	CERCIDIPHYLLUM JAPONICUM	KATSURA TREE	2.5" CAL.	B&B		ILEX CRENATA `CONVEXA`	CONVEX-LEAVED JAPANESE HOLLY	5 GAL.	CONT.	30" o.c.	
	FRONT YARD TREES				+	ILEX CRENATA `CONVEXA` *	CONVEX-LEAVED JAPANESE HOLLY	2 GAL.	CONT.	36" o.c.	
	ACER PALMATUM LAGERSTROEMIA X `TUSCARORA`	MULTI-TRUNK JAPANESE MAPLE RED CRAPE MYRTLE MULTI-TRUNK	MULTI-STEM, 6` HT. MULTI-STEM, 6` HT.			PIERIS JAPONICA 'CAVATINE'	LILY OF THE VALLEY BUSH	5 GAL.	CONT.	36" o.c.	
000000000						PITTOSPORUM TOBIRA 'WHEELER'S DWARF'	DWARF PITTOSPORUM	5 GAL.	CONT.	36" o.c.	EFE TO
• 000	FRONT YARD TREES - ENTRY				Rc2	RHODODENDRON KURUME 'CORAL BELLS'	CORAL BELLS KURUME AZALEA	5 GAL.	CONT.	36" o.c.	
000000000	MAGNOLIA STELLATA `WATERLILY`	STAR MAGNOLIA	MULTI-STEM, 6` HT.	B&B	Rs	RHODODENDRON X 'SEAVIEW SUNSET'	SEAVIEW SUNSET RHODODENDRON	5 GAL.	CONT.	48" o.c.	TS
					£ <del>1</del> 3	ROSA X `AMBER CARPET ROSE`	ROSE	5 GAL.	CONT.	36" o.c.	
						SPIRAEA BETULIFOLIA 'TOR' FULL/COMPACT	TOR BIRCH LEAF SPIREA	2 GAL.	CONT.	30" o.c.	<b>∑</b>   <b>⊢</b>
	STREET TREES - E LYNN ST CONCEPTUAL APPROVAL I SDOT TREE0002808.	BY SDOT URBAN FORESTRY 11/19/2021, REG	CORD NUMBER:		Th &	TAXUS X MEDIA `HICKSII`	HICKS YEW	5` HT.	CONT.	48" o.c.	AR
	SDOT IKLLOODZOOD.				<b>(A)</b>	VACCINIUM OVATUM	EVERGREEN HUCKLEBERRY	5 GAL.	CONT.	36" o.c.	AP.
$\sim$	CORNUS KOUSA X NUTTALLII 'KN4-43'	STARLIGHT KOUSA DOGWOOD	2.5" CAL.	B&B	Vd	VIBURNUM DAVIDII	DAVID VIBURNUM	5 GAL.	CONT.	36" o.c.	ST
• J	BACK YARD TREES		0 10) 111 1411111	D o D	ANNUALS/PERENNIALS	BOTANICAL NAME	COMMON NAME	<u>SIZE</u>	COND DROUGHT	<u>SPACING</u>	
. 3	STEWARTIA PSEUDOCAMELLIA	JAPANESE STEWARTIA	8-10` HT, MULTI	B&B	*	ASTILBE X 'PEACH BLOSSOM'	PEACH BLOSSOM ASTILBE	1 GAL.	CONT.	18" o.c.	
4 m					€3	ASTILBE X ARENDSII 'DEUTSCHLAND'	DEUTSCHLAND ASTILBE	1 GAL.	CONT.	18" o.c.	DRAWING IS
						DISPOROPSIS PERNYI	EVERGREEN SOLOMON'S SEAL	2 GAL.	CONT.	24" o.c.	Date 11.23.202
	MATERIALS LIST				<b>◆</b>	DRYOPTERIS ERYTHROSORA	AUTUMN FERN	1 GAL.	CONT.	18" o.c.	
		ING - TYPE A AN 420 W/ THE FOLLOWING EXCEPTIONS: THROUGH JOINTS			袋	HELLEBORUS X HYBRIDUS	HELLEBORE	1 GAL.	CONT.	12" o.c.	
	-SAW CUT JOINT -LIGHT SAND BLA -SCORE PER PLA	TS AST			Sept.	SESLERIA AUTUMNALIS	AUTUMN MOOR GRASS	2 GAL.	CONT.	18" o.c.	
	T_ THROUGH JOINT				GROUND COVERS	BOTANICAL NAME	COMMON NAME	SIZE	COND DROUGHT	<u>SPACING</u>	2
	BIKE RACK TOFINO NO SCR RACK, INSTALL P					EPIMEDIUM PINNATUM	EPIMEDIUM PINNATUM	1 GAL.	CONT. DROUGHT TOLERANT	18" o.c.	
	RECOMMENDAT				+++++++ ++++++ ++++++ ++++++ ++++++ ++++	LIRIOPE MUSCARI `BIG BLUE`	BIG BLUE LILYTURF	1 GAL.	CONT.	12" o.c.	
					6 6 6 6 6 6 6 6 6 6 6 6 6 6 6 6 6 6 6	OPHIOPOGON PLANISCAPUS `NIGRESCENS`	BLACK MONDO GRASS	1 GAL.	CONT.	12" o.c.	SHEET TI
						PACHYSANDRA TERMINALIS	JAPANESE SPURGE	1 GAL.	CONT.	12" o.c.	LAND
											SHEET NO

Karen Kiest dscape Architects 1 west john street suite 306 seattle washington 98119



APARTMENTS

78 E Lynn St, Sea

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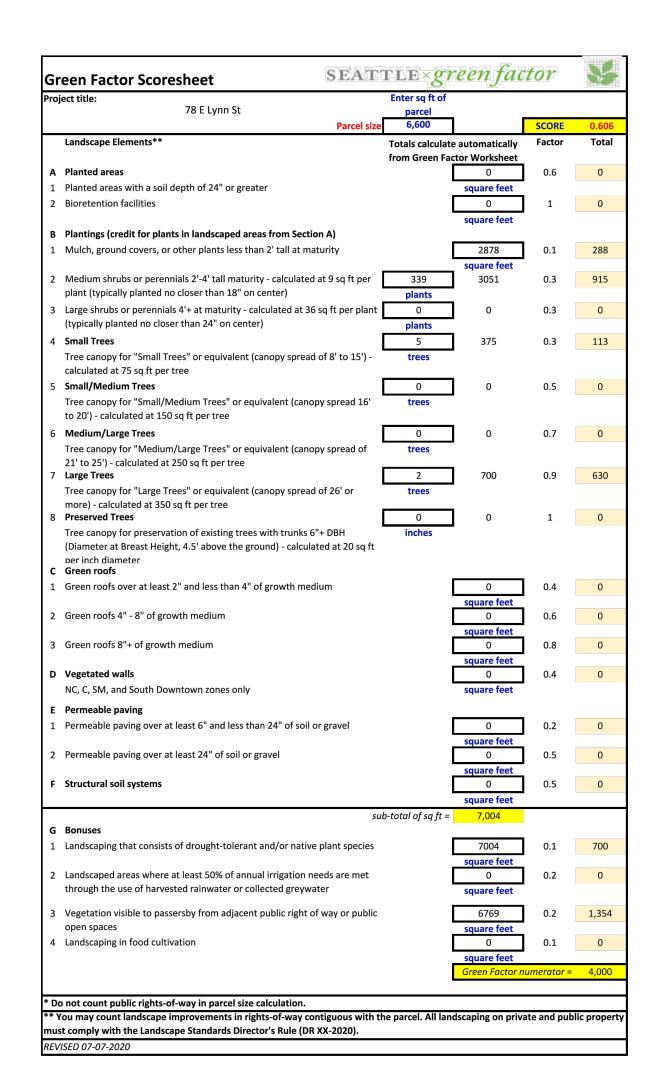
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LANDSCAPE PLAN


SHEET NO.

L100A





Green	Factor Work	sheet SEATTLE×green factor							
Project title:  78 E Lynn St  Landscape Elements  Measurement		Planting Area							
		Right of Way	Site - Visible	Site Non-Vis	rename (4)	rename (5)	rename (6)	rename (7)	
		Step 1. Enter all values for Green Factor landscape elements here. Values entered here will automatically populate the Score Sheet.  Step 2. Go to the Score Sheet and enter the size of the development site.							
		Step 3. Check the Score to make sure your project meets the minimum score for the zone.  *Totals on the Green Factor Scoresheet will calculate automatically							
A1	square feet						l		Tota 0
A2	square feet	+							0
B1	square feet	1100	1645	133					287
B2	# of plants	122	214	3					339
В3	# of plants								0
B4	# of trees	4		1					5
B5	# of trees								0
В6	# of trees	1							0
B7	# of trees	2							2
B8	Inches DBH								0
C1	square feet								0
C2	square feet								0
C3	square feet								0
D	square feet								0
E1	square feet								0
E2	square feet								0
F	square feet								0
G1	square feet	3198	3571	235					700
G2	square feet								0
G3	square feet	3198	3571						676
G4	square feet								0

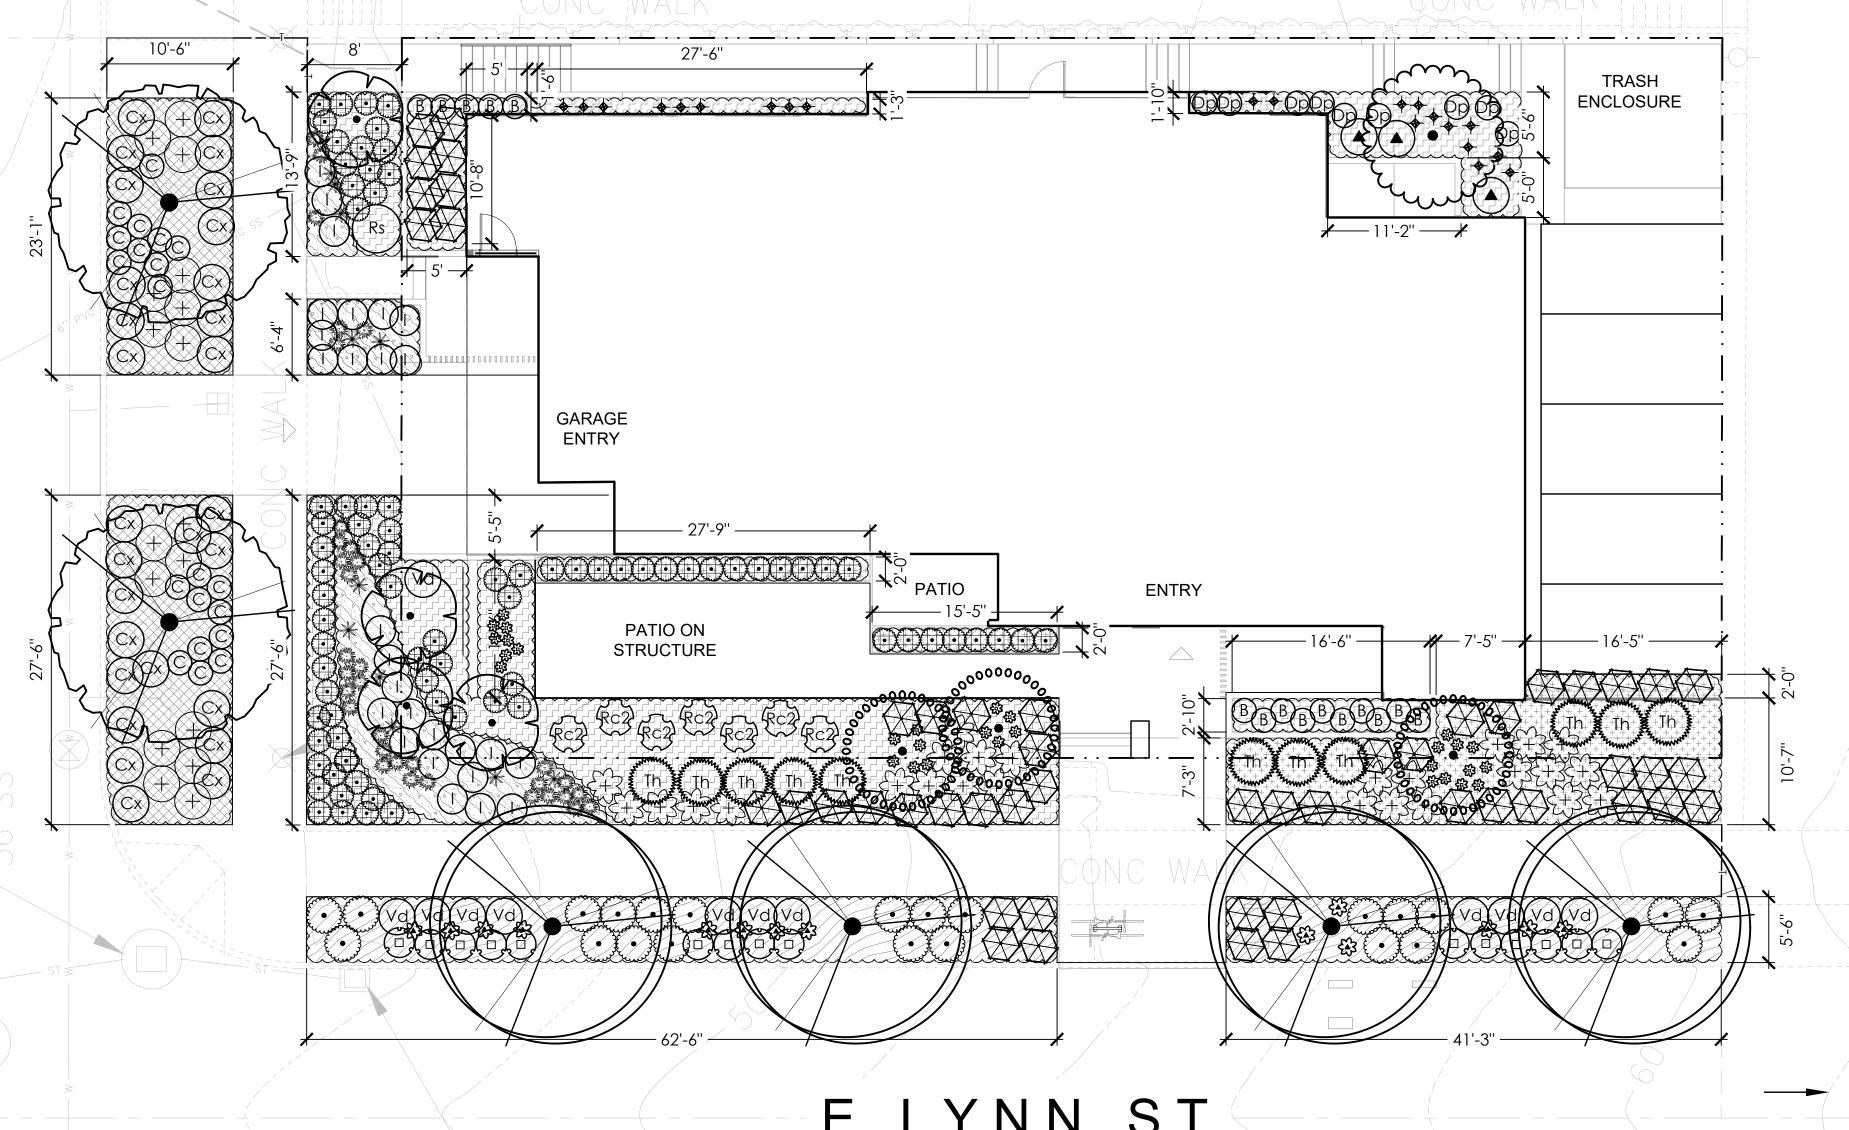

### E LYNN ST

Seattle Green Factor Plan scale 1/8" = 1' - 0"



11.23.2021

### SEATTLE GREEN FACTOR NOTES:

PER CITY OF SEATTLE DEPARTMENT OF CONSTRUCTION & INSPECTIONS DIRECTOR'S RULE 11-2020, THE FOLLOWING LANDSCAPE INFORMATION: 1. IN REQUIRED LANDSCAPE AREAS, AT LEAST 50% OF ALL PLANTINGS

- MUST BE DROUGHT TOLERANT. 2. PROJECT MEETS 0.60 SEATTLE GREEN FACTOR SCORE, SEE SPREADSHEET FOR CALCULATIONS.
- 3. DIMENSIONS USED ONLY FOR GREEN FACTOR CALCULATIONS. SEE LANDSCAPE PLANS AND DETAILS FOR CONSTRUCTION DIMENSIONS. SEE ALSO CIVIL & ARCHITECTURAL DWGS.
- 4. ALL PLANTINGS AND LANDSCAPE ELEMENTS REQUIRED AS PART OF THIS BUILDING PERMIT MUST BE MAINTAINED FOR THE LIFE OF THE PROJECT. IF ALTERATIONS OR FAILURES REDUCE LANDSCAPE FEATURES TO A LEVEL BELOW THE MINIMUM REQUIRED PLANTING AREA OR GREEN FACTOR SCORE, NEW FEATURES MUST BE ADDED TO COMPENSATE.

Karen Kiest e Architects



## LWEN


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SHEET TITLE

SEATTLE GREEN FACTOR PLAN

SHEET NO.

**L200** 

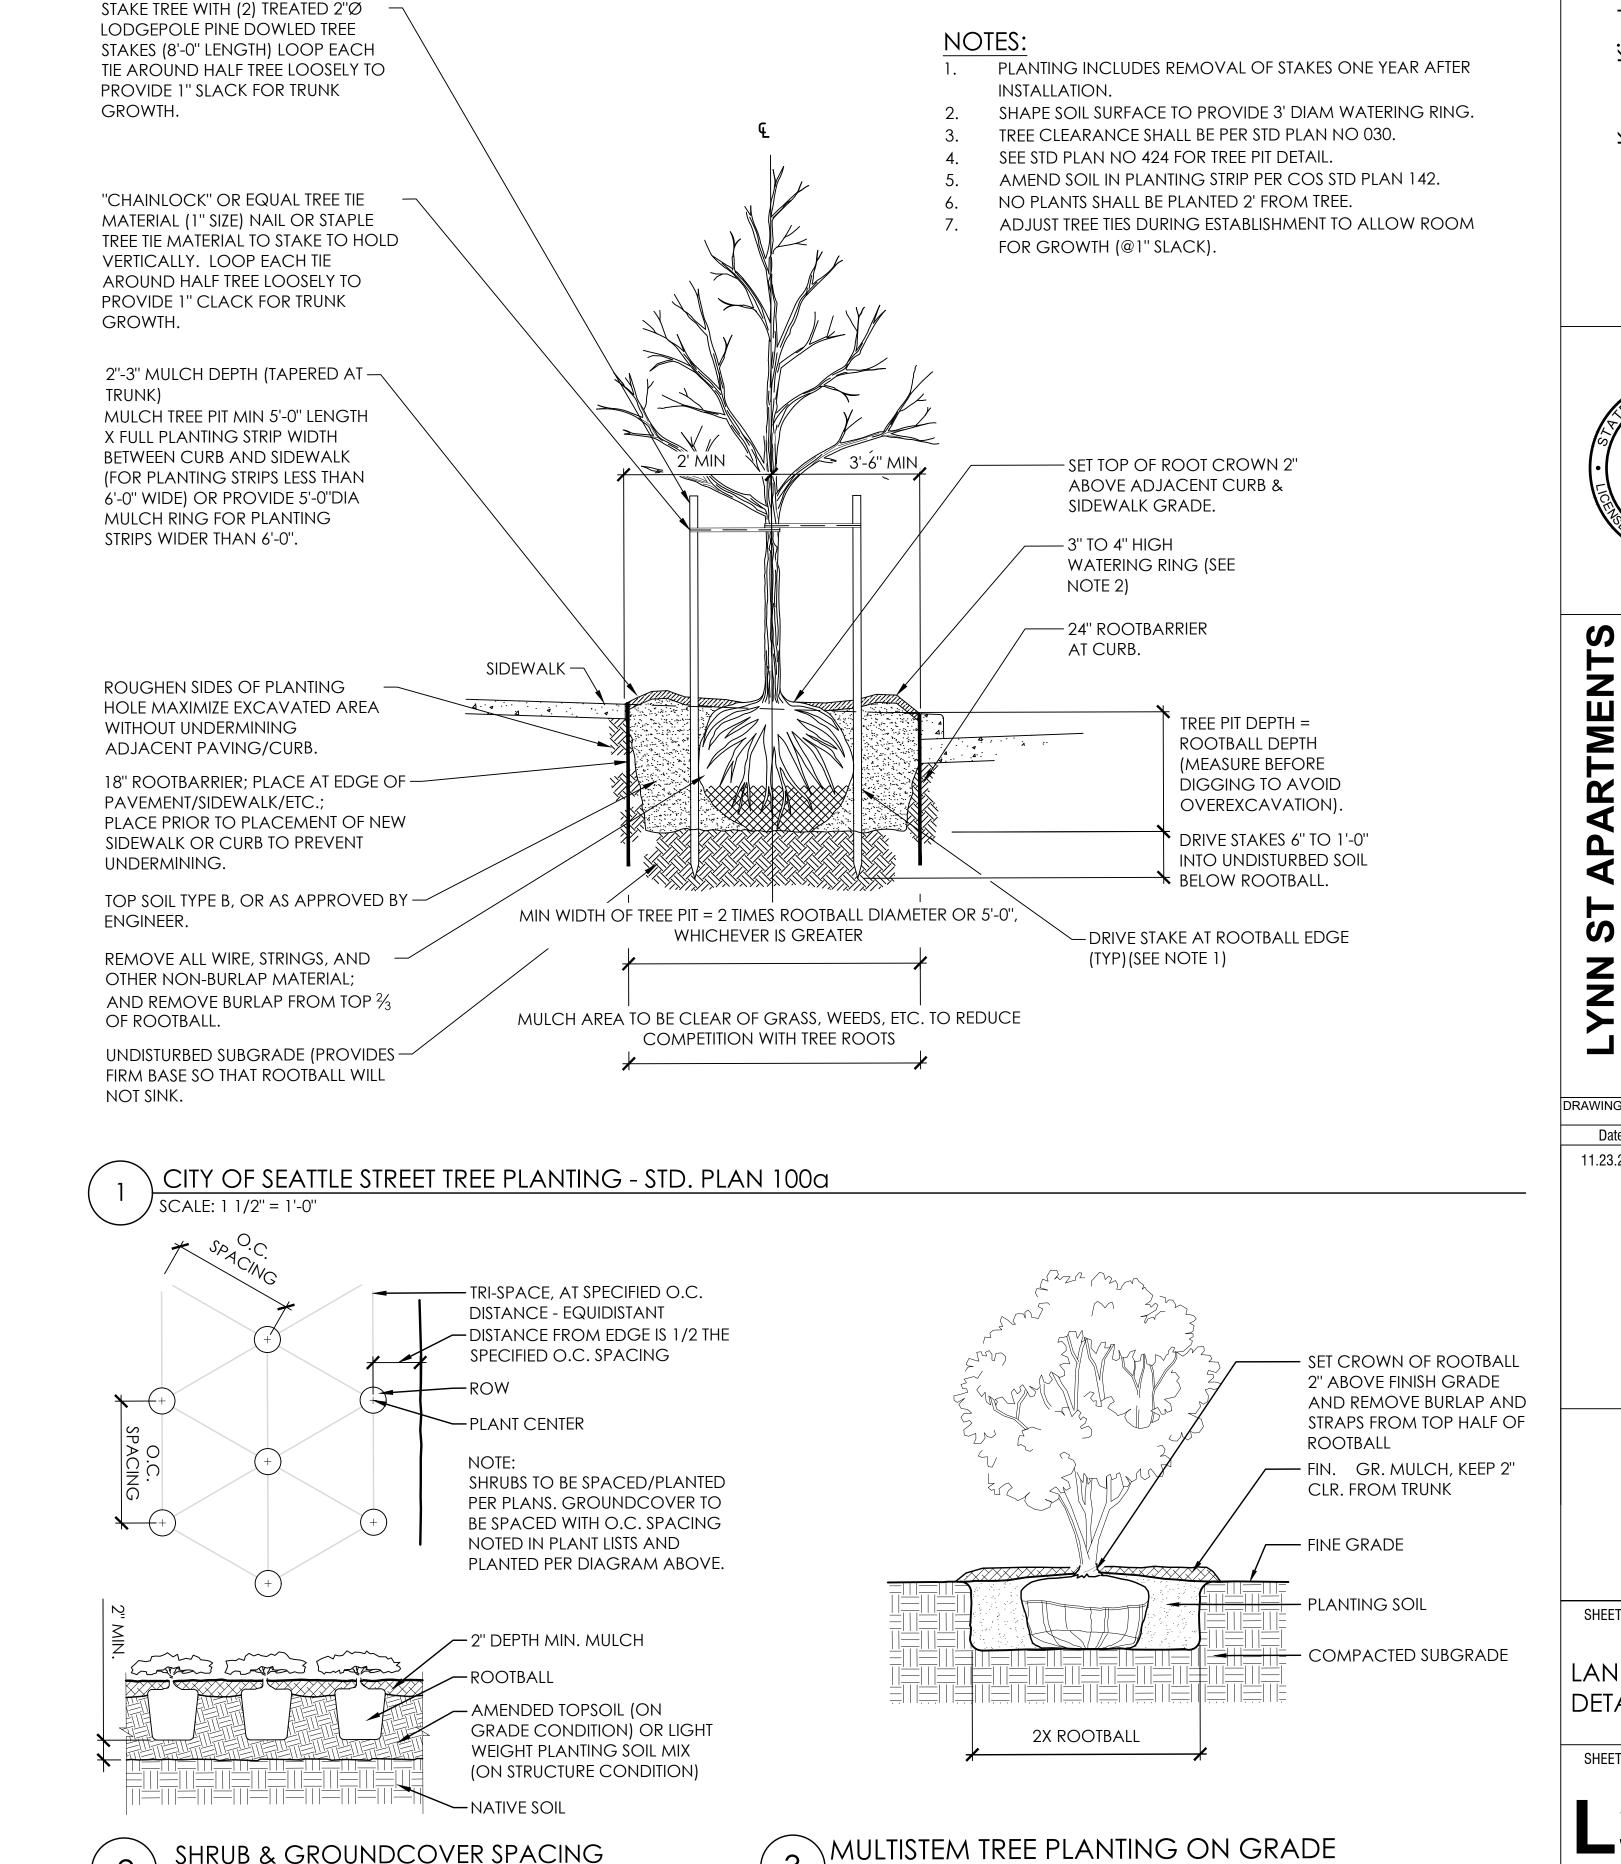

SCALE: 1" = 1'-0"

SHRUB & GROUNDCOVER SPACING

SCALE: 1"=1'-0"

Karen Kiest e Architects reet ingt 206 indscap(



### RTMENTS

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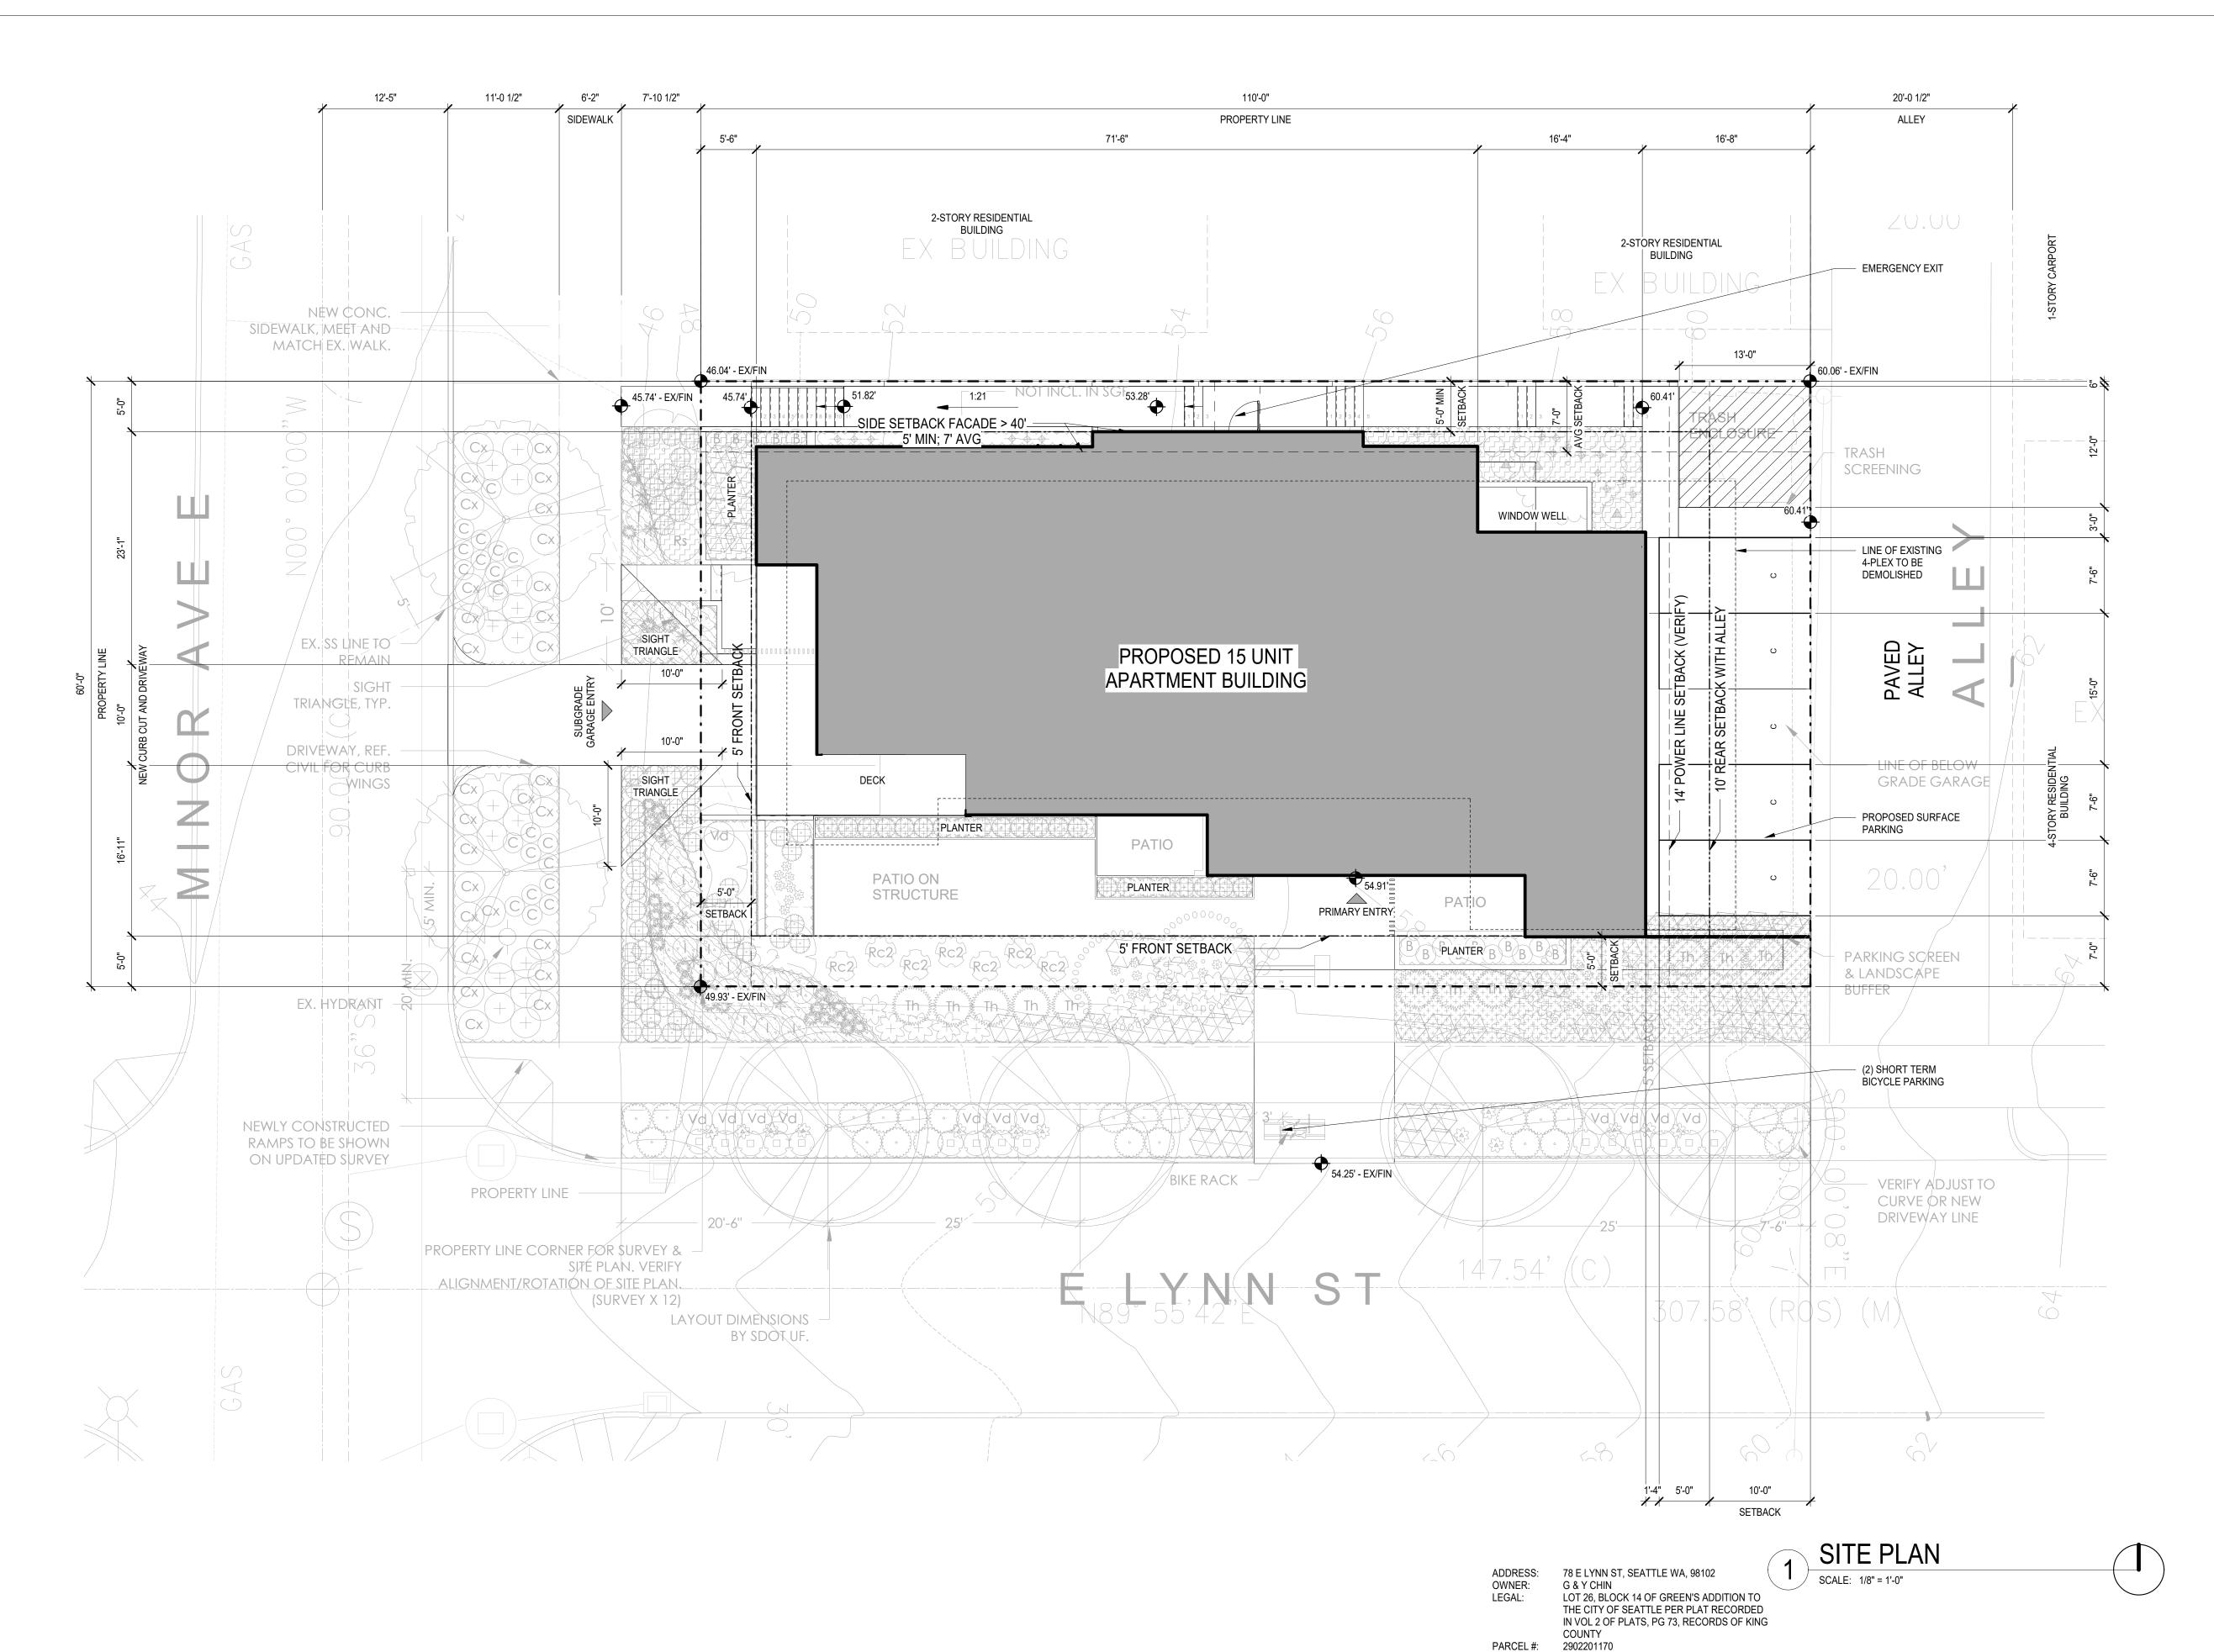
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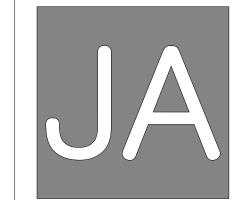
LANDSCAPE DETAILS

SHEET NO.

LYNN-LANDSCAPE DETAILS.DWG

L300







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78 E Lynn St, Seattle WA, 98102

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DATE DESCRIPTION
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SITE PLAN

SHEET NO.

A100


### SIGNAGE & LIGHTING NOTES

SITE PLAN DIAGRAM SHOWN IS A COMPOSITE OF GROUND FLOOR TO ROOF DECK USES; MULTIPLE FLOORS ARE REPRESENTED; LIGHT FIXTURES ARE LABELED TO INDICATE THE FLOOR ON WHICH THEY ARE INSTALLED

 ALL EXTERIOR LIGHT FIXTURES MUST BE SHIELDED AND DIRECTED AWAY FROM ADJACENT RESIDENTIAL PROPERTIES.

### SITE SIGNAGE & LIGHTING LEGEND


- WALL-MOUNTED SCONCE LIGHTING (UP-DOWN AT OVERHANG AREAS; DOWNLIT-ONLY WHERE NO OVERHANG ABOVE)
- LANDSCAPE LIGHTING
- WALL-MOUNTED INTERNALLY-ILLUMINATED SIGN FOR BUILDING NAME

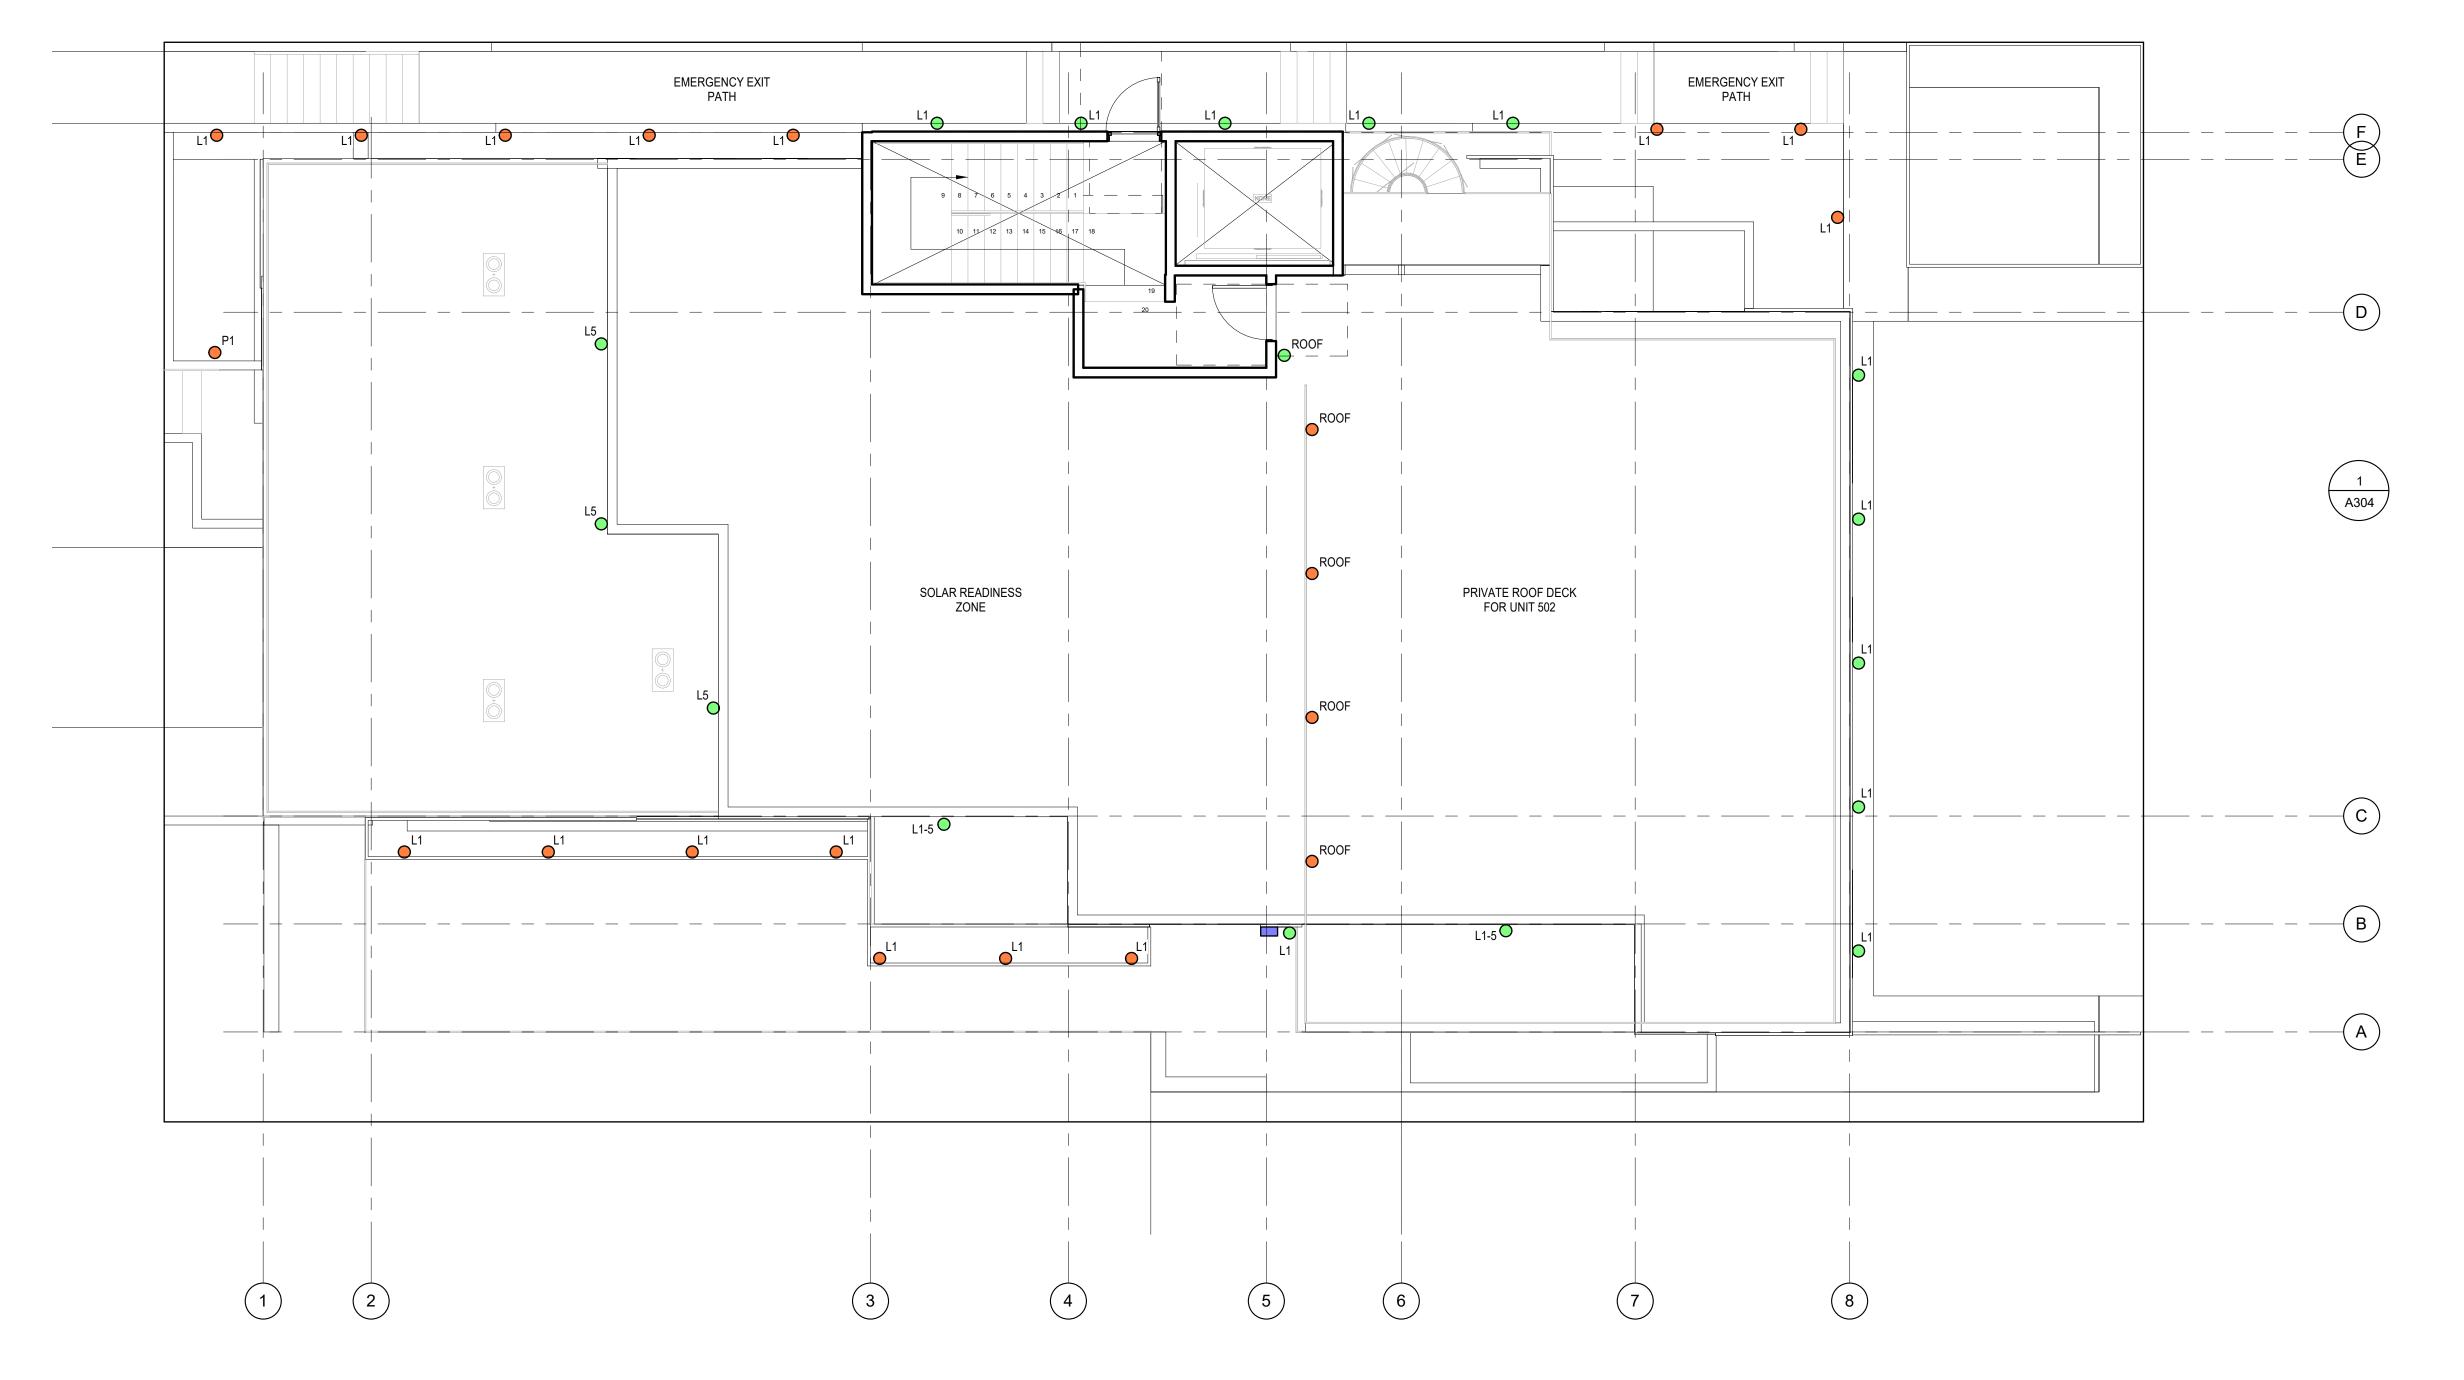



SITE LIGHTING & SIGNAGE

SCALE: 3/16" = 1'-0"

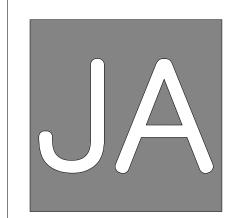

Johnston Architects, LLC 100 NE Northlake Way, Suite 200 Seattle, WA 98105 t 206.523.6150 f 206.523.9382



APARTMENTS

78 E Lynn St, Seattle WA, 98

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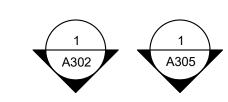
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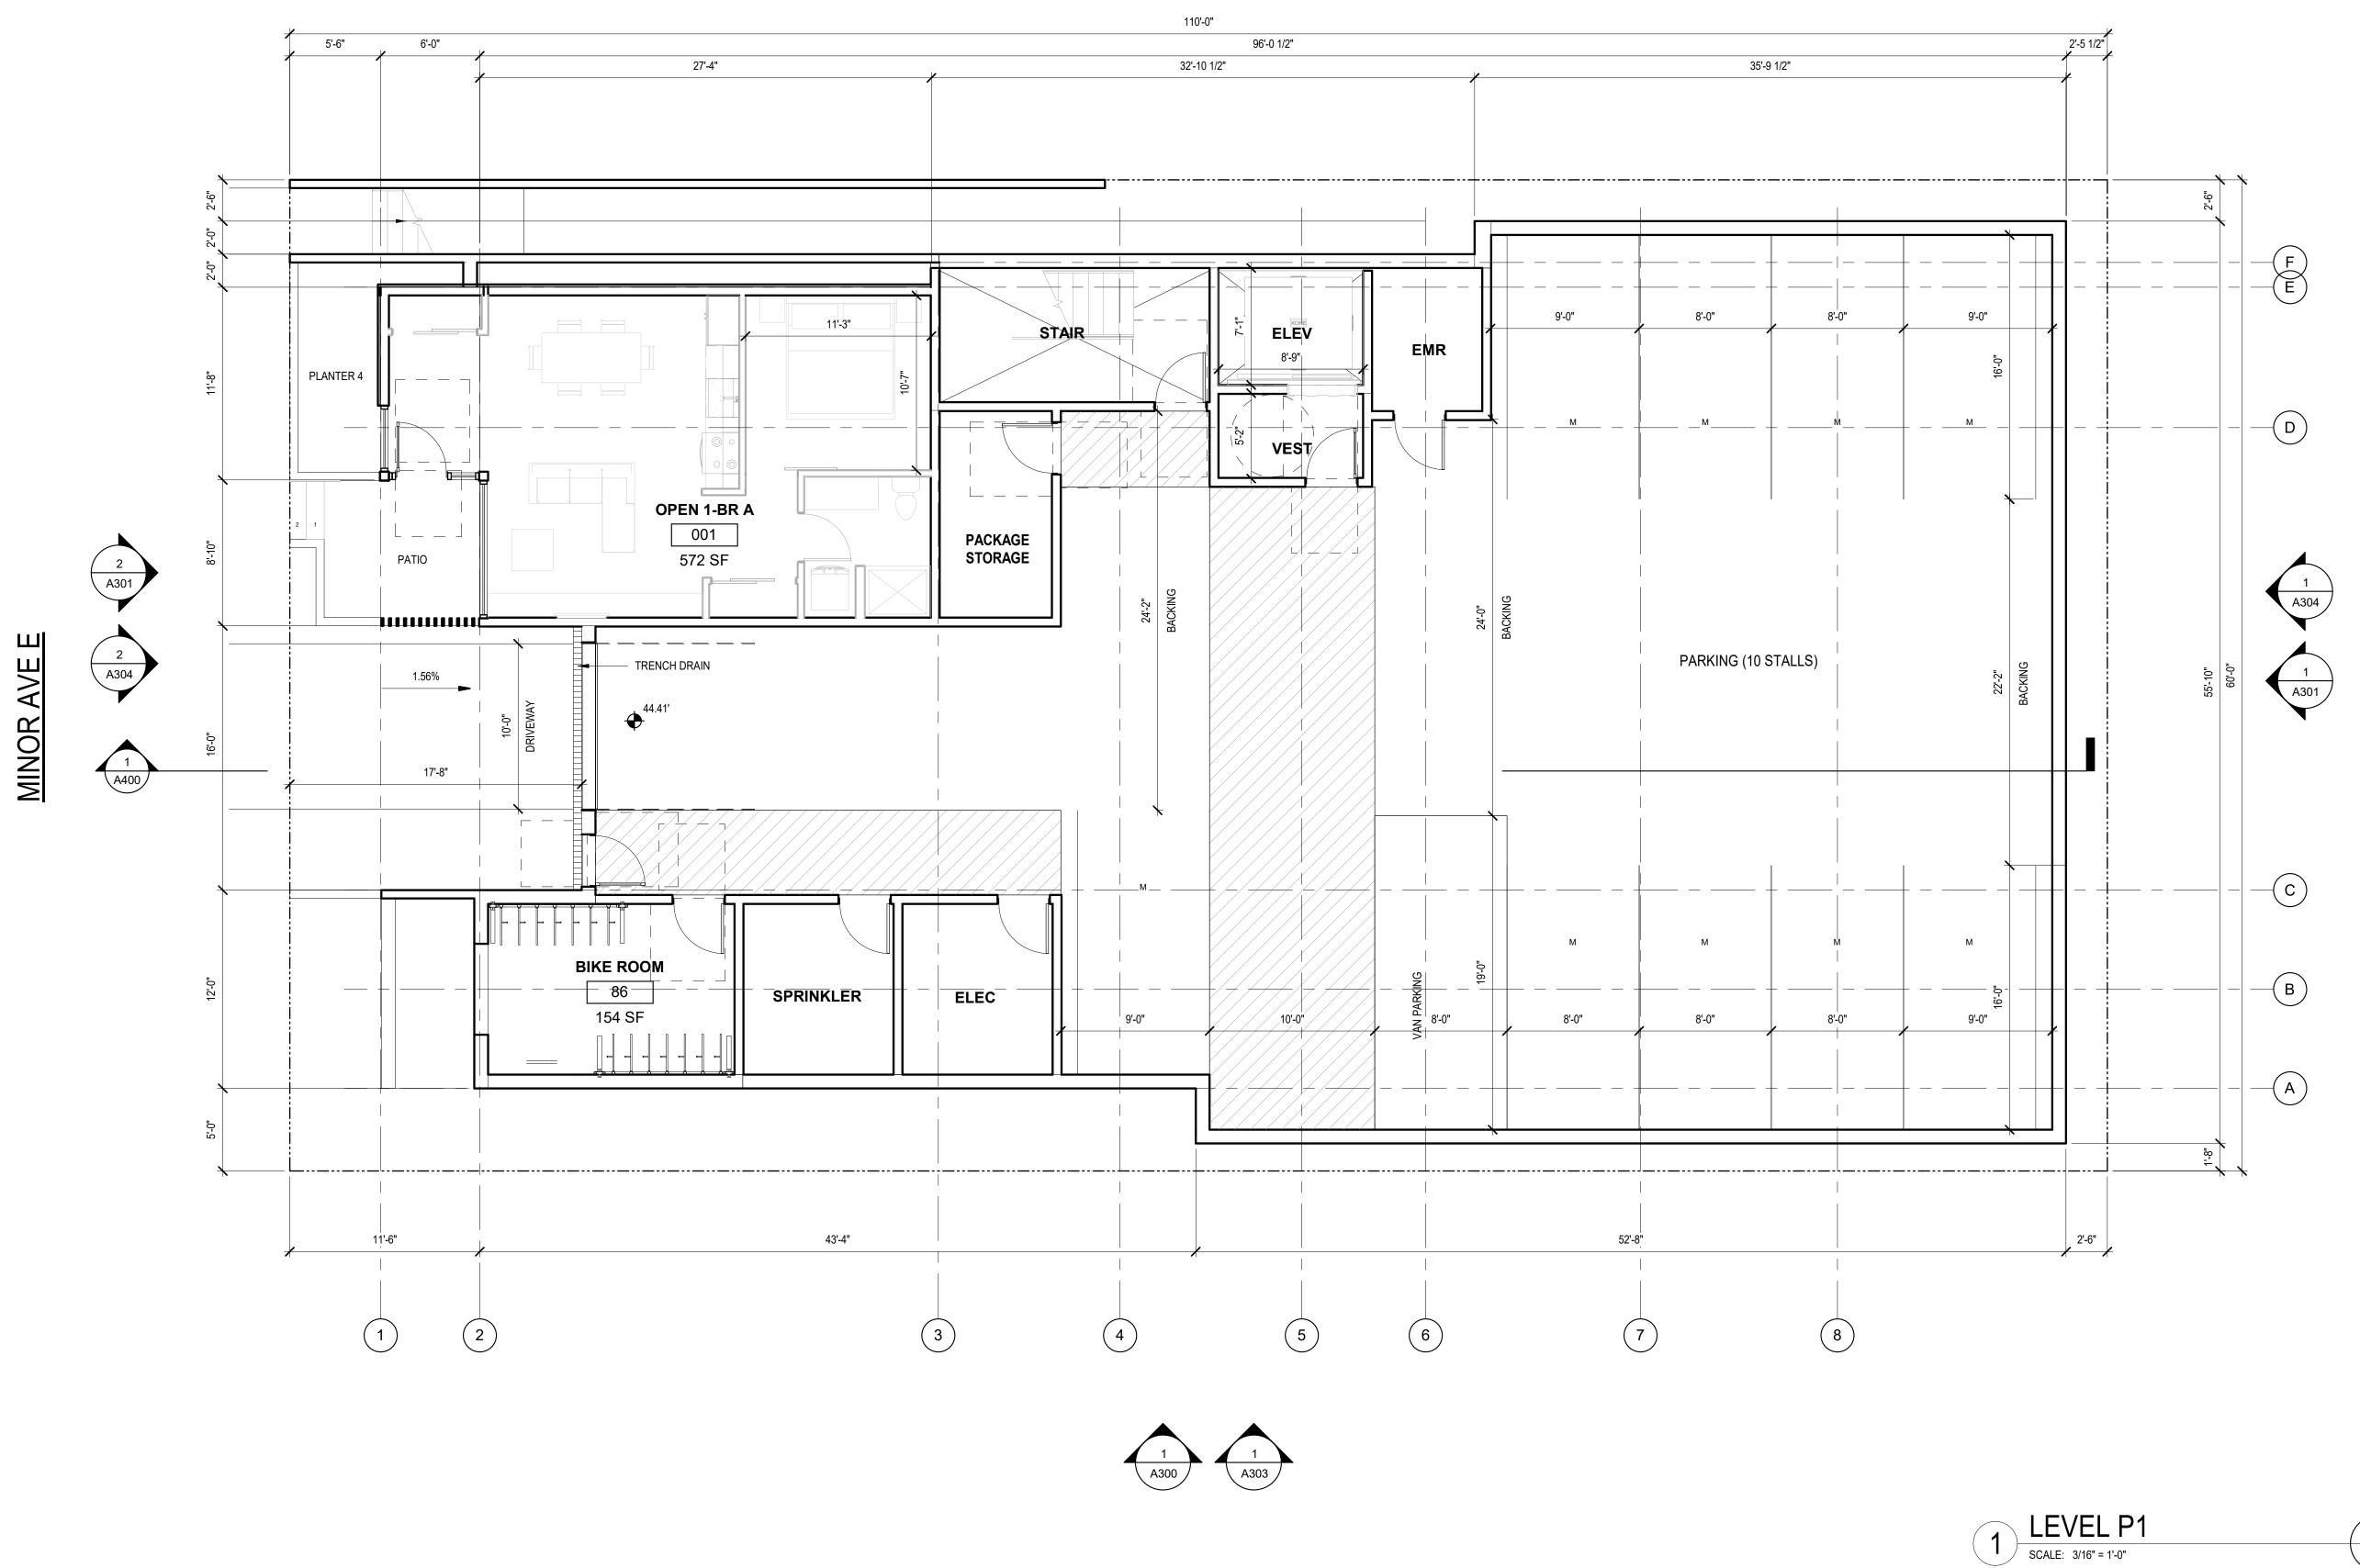
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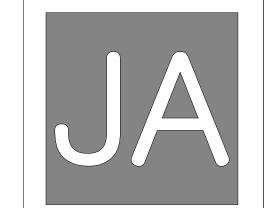
SITE LIGHTING & SIGNAGE

SHEET NO.

A101









ST APARTMENTS

78 E Lynn St, Seattle WA, 981

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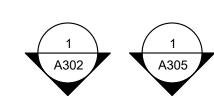
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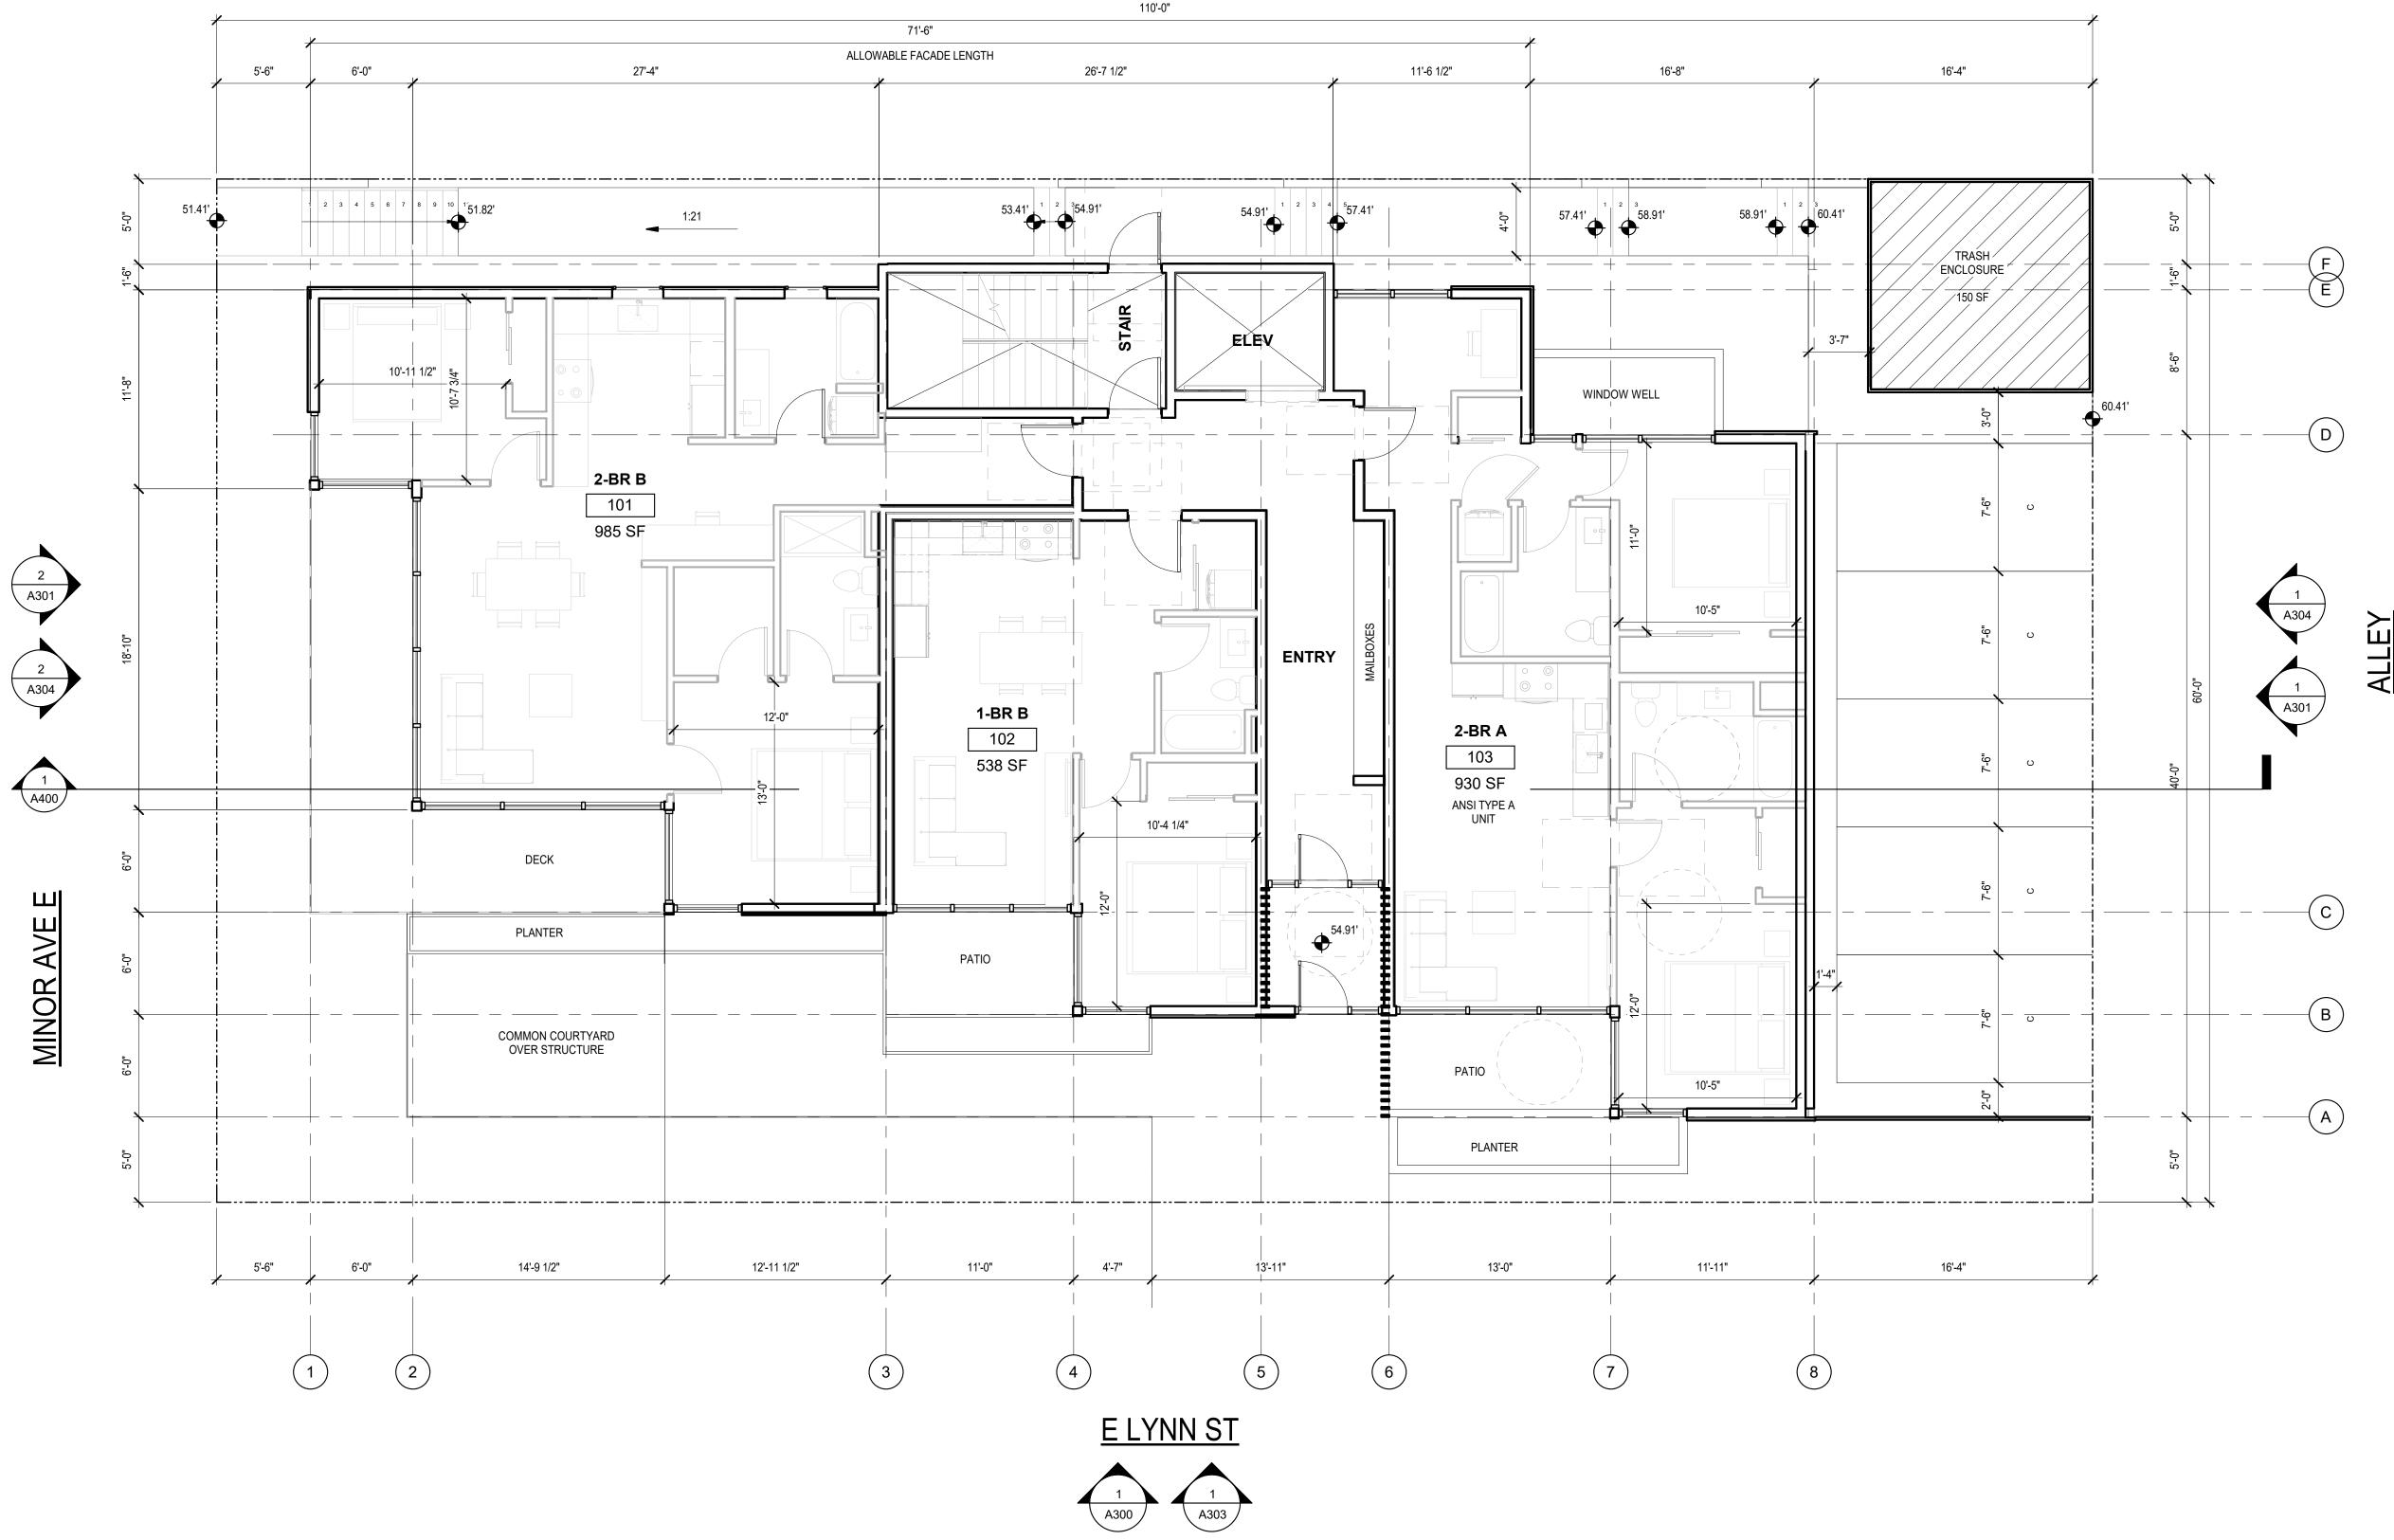
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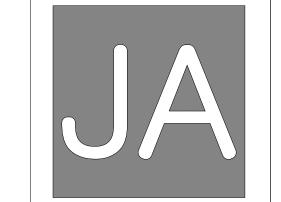
PLANS

SHEET NO.

**A200** 









ST APARTMENTS

파 78 E Lynn St, Seattle WA, 98102

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LYNN

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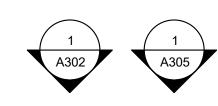
PLANS


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SHEET NO.

1 LEVEL 1
SCALE: 3/16" = 1'-0"

A201





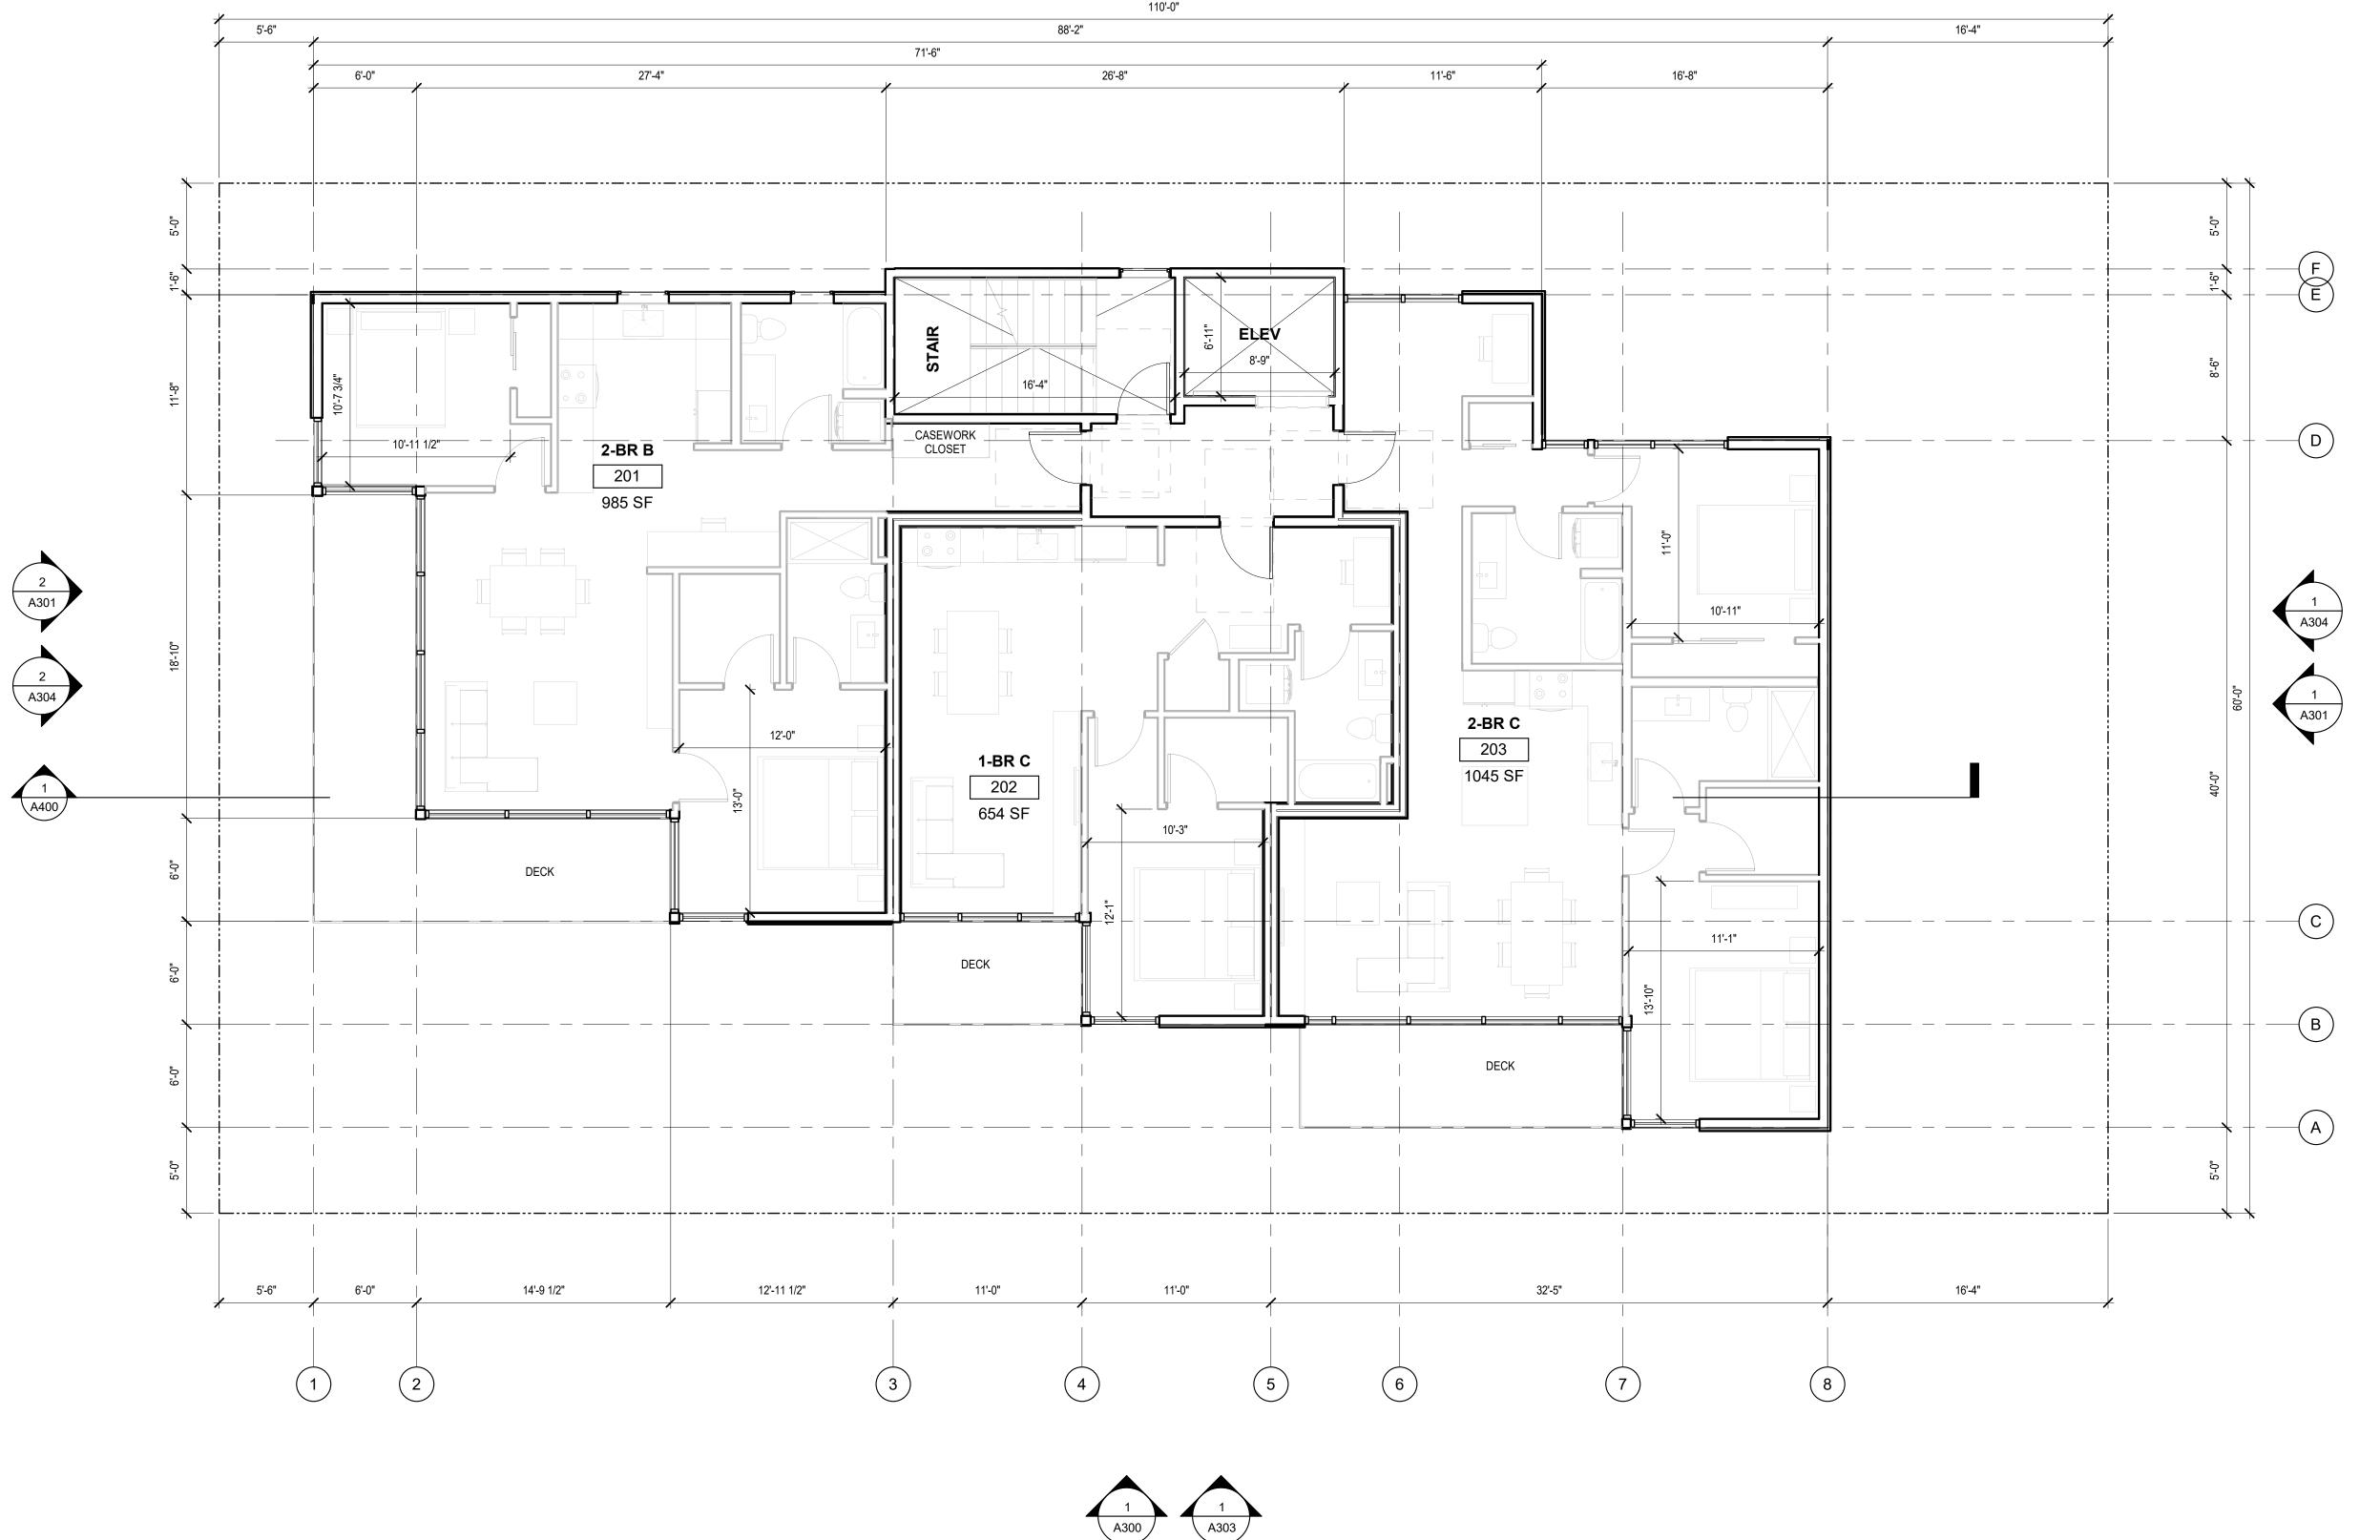



LYNN ST APARTMENTS

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**PLANS** 


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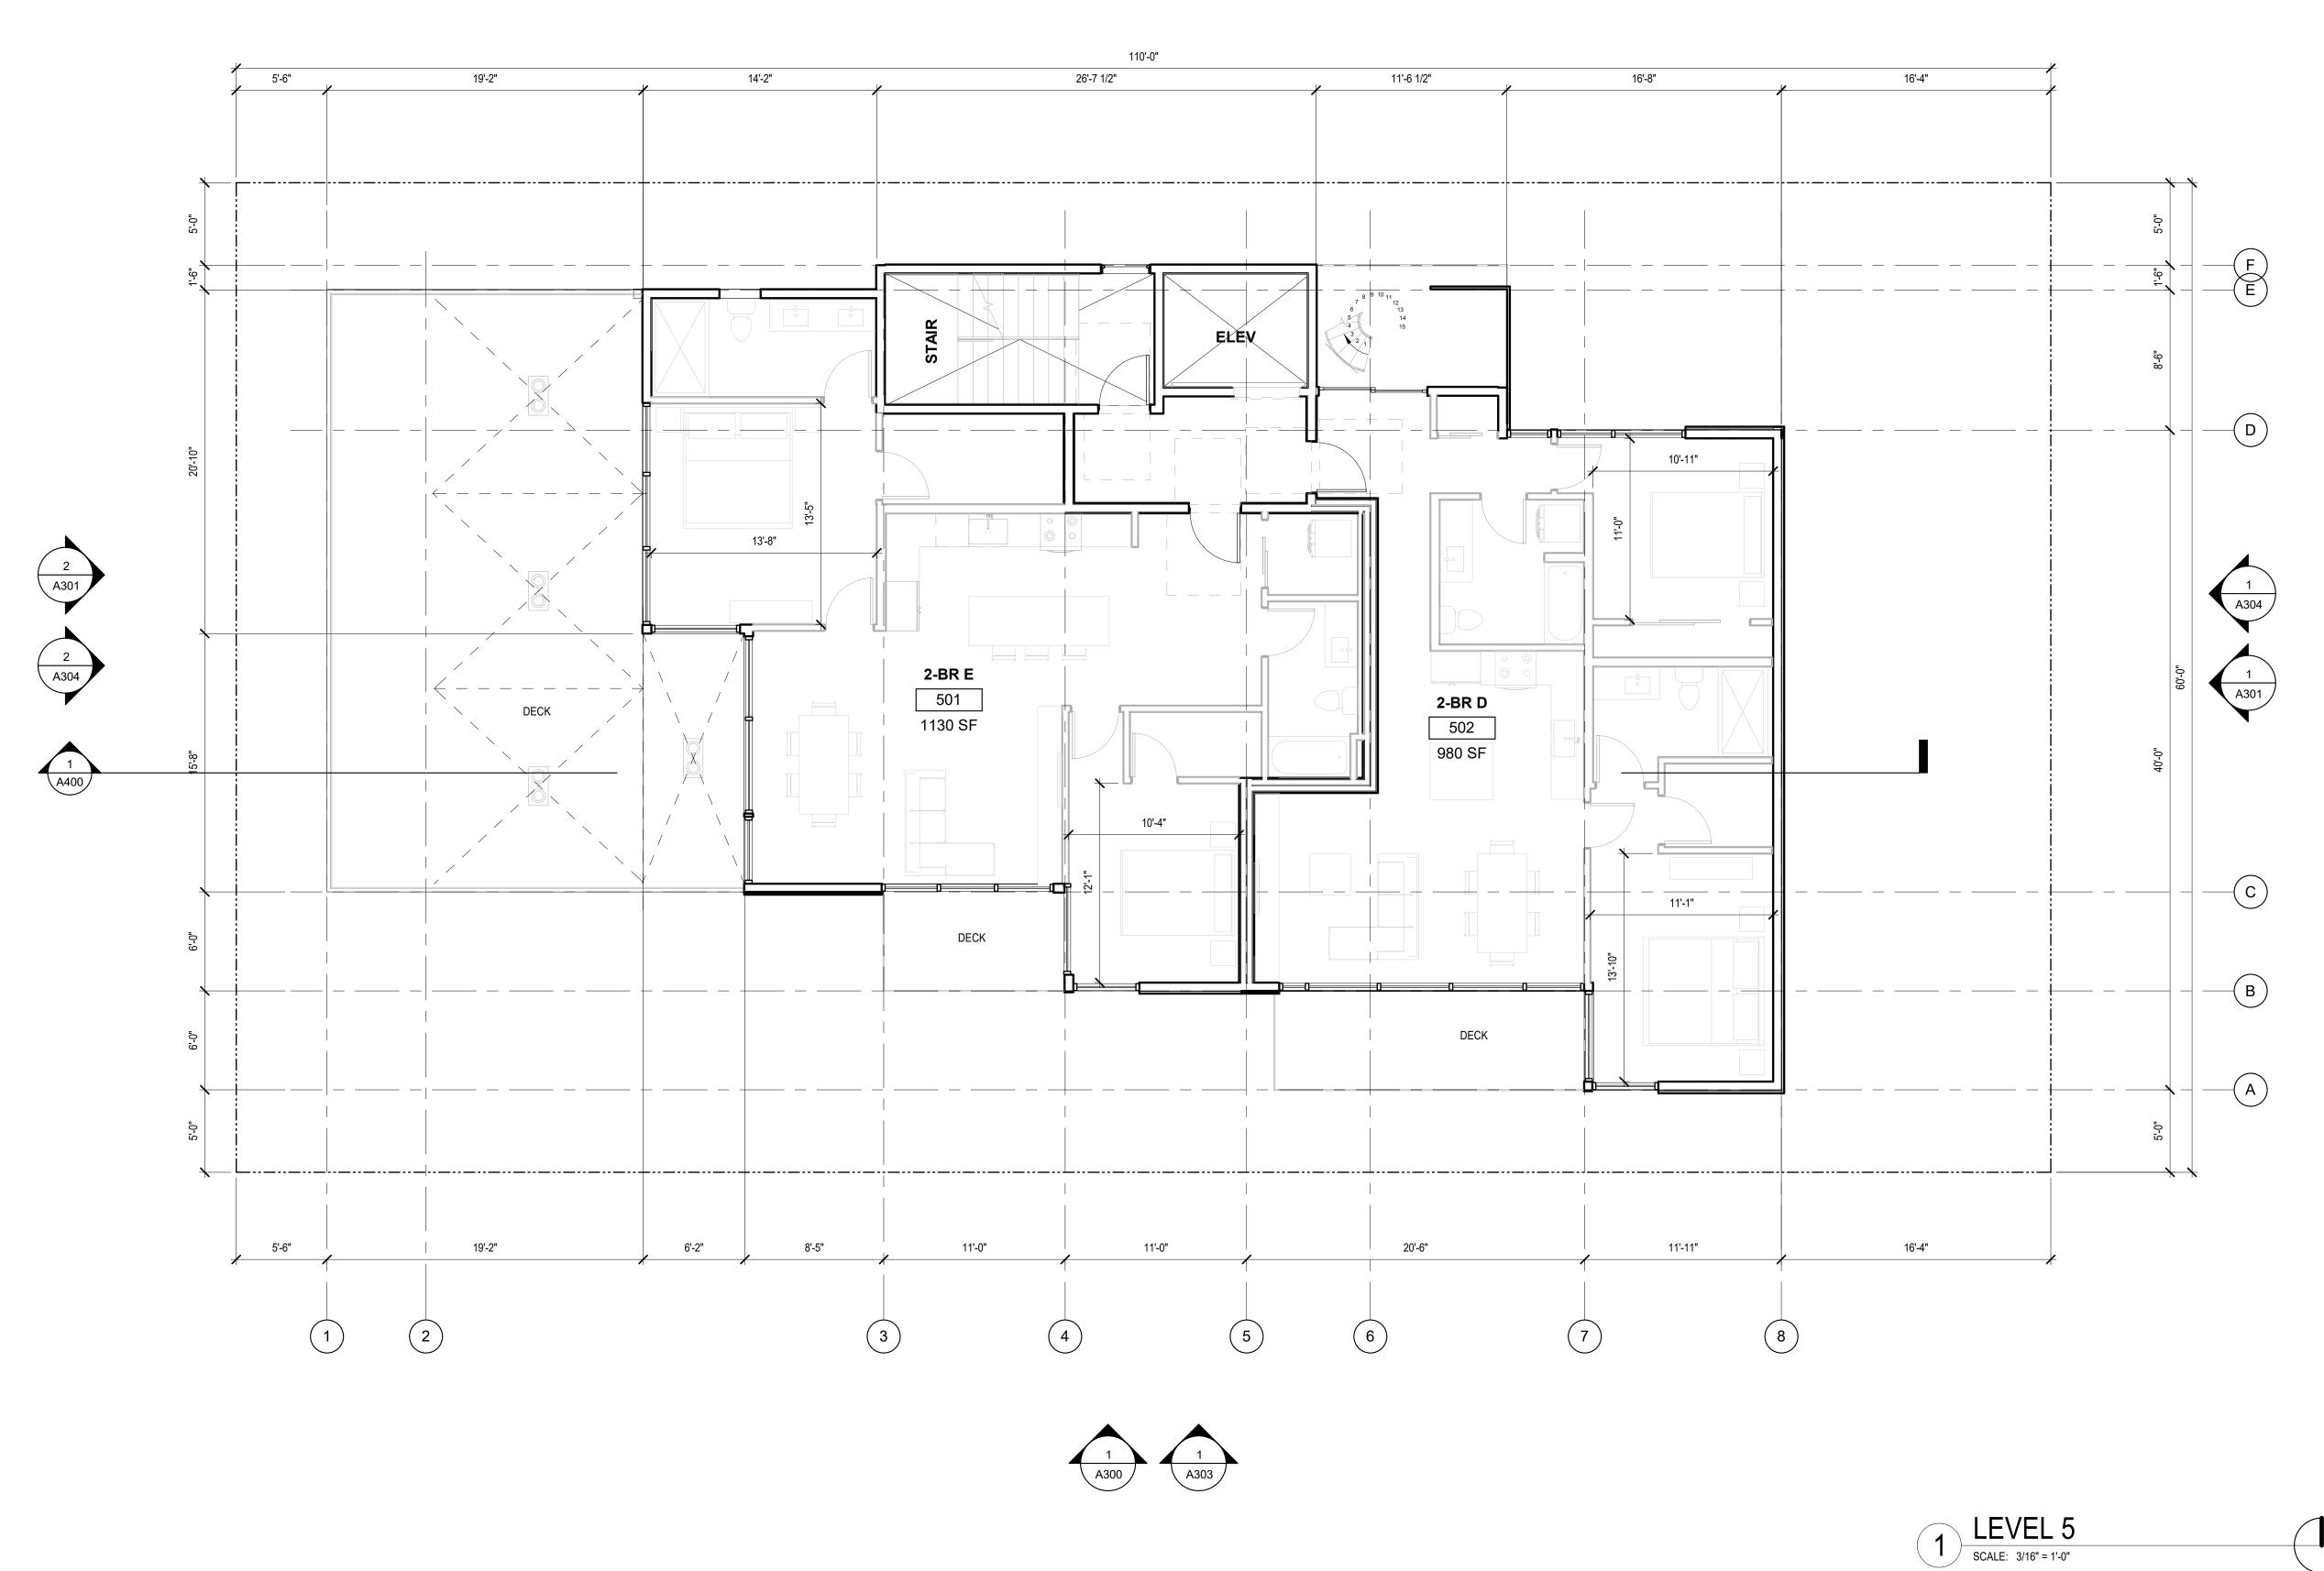
LEVEL 2-4

SCALE: 3/16" = 1'-0"

LEVEL 2 SHOWN (LEVEL 3 AND LEVEL 4 IDENTICAL)

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LYNN ST APARTMENTS

DRAWING ISSUE DESCRIPTION

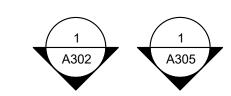2021.11.23 MUP INTAKE


SHEET TITLE

**PLANS** 

SHEET NO.

**A203** 

Drawn Checked © 2019 JOHNSTON ARCHITECTS

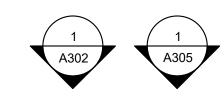







APARTMENTS

78 E Lynn St, Seattle WA, 9810

DRAWING ISSUE

ST

LYNN


DATE DESCRIPTION
2021.11.23 MUP INTAKE

SHEET TITLE

PLANS

SHEET NO.

A204

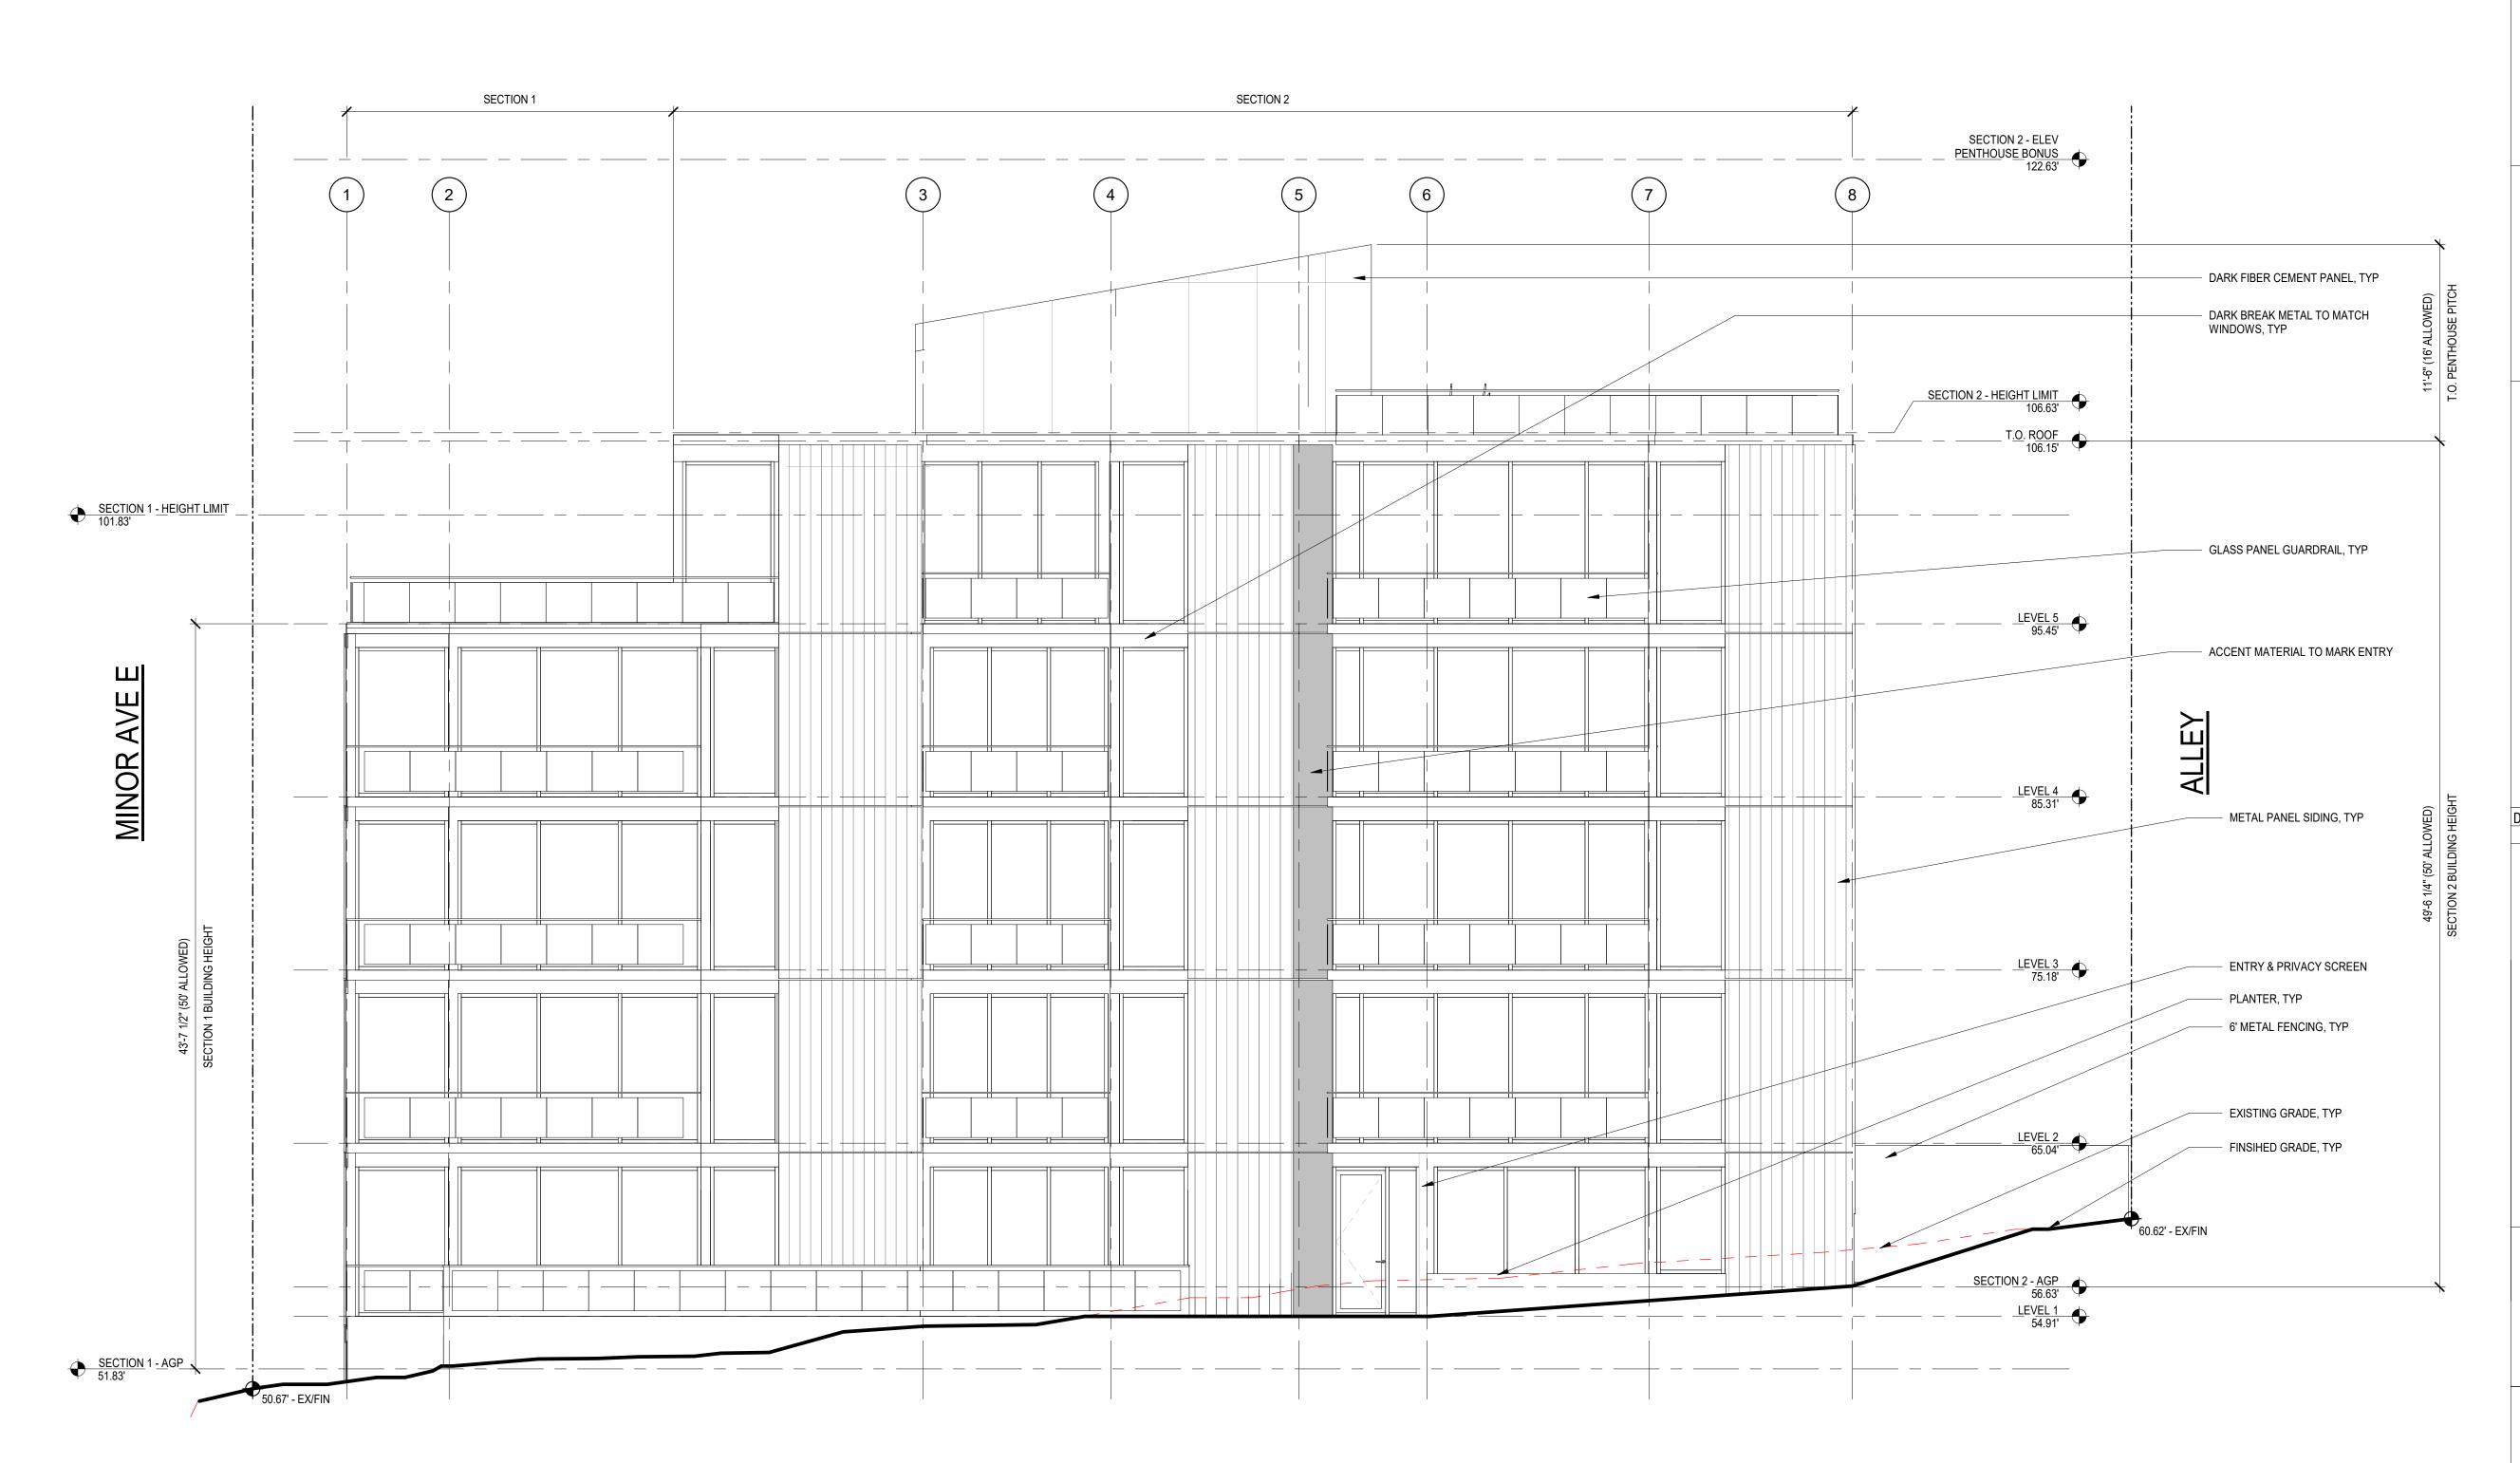







APARTMENTS

ST

LYNN

78 E Lynn St, Seattle WA, 981

DRAWING ISSUE

DATE

DESCRIPTION

2021.11.23


MUP INTAKE

SHEET TITLE

**ELEVATIONS** 


SHEET NO.

A300

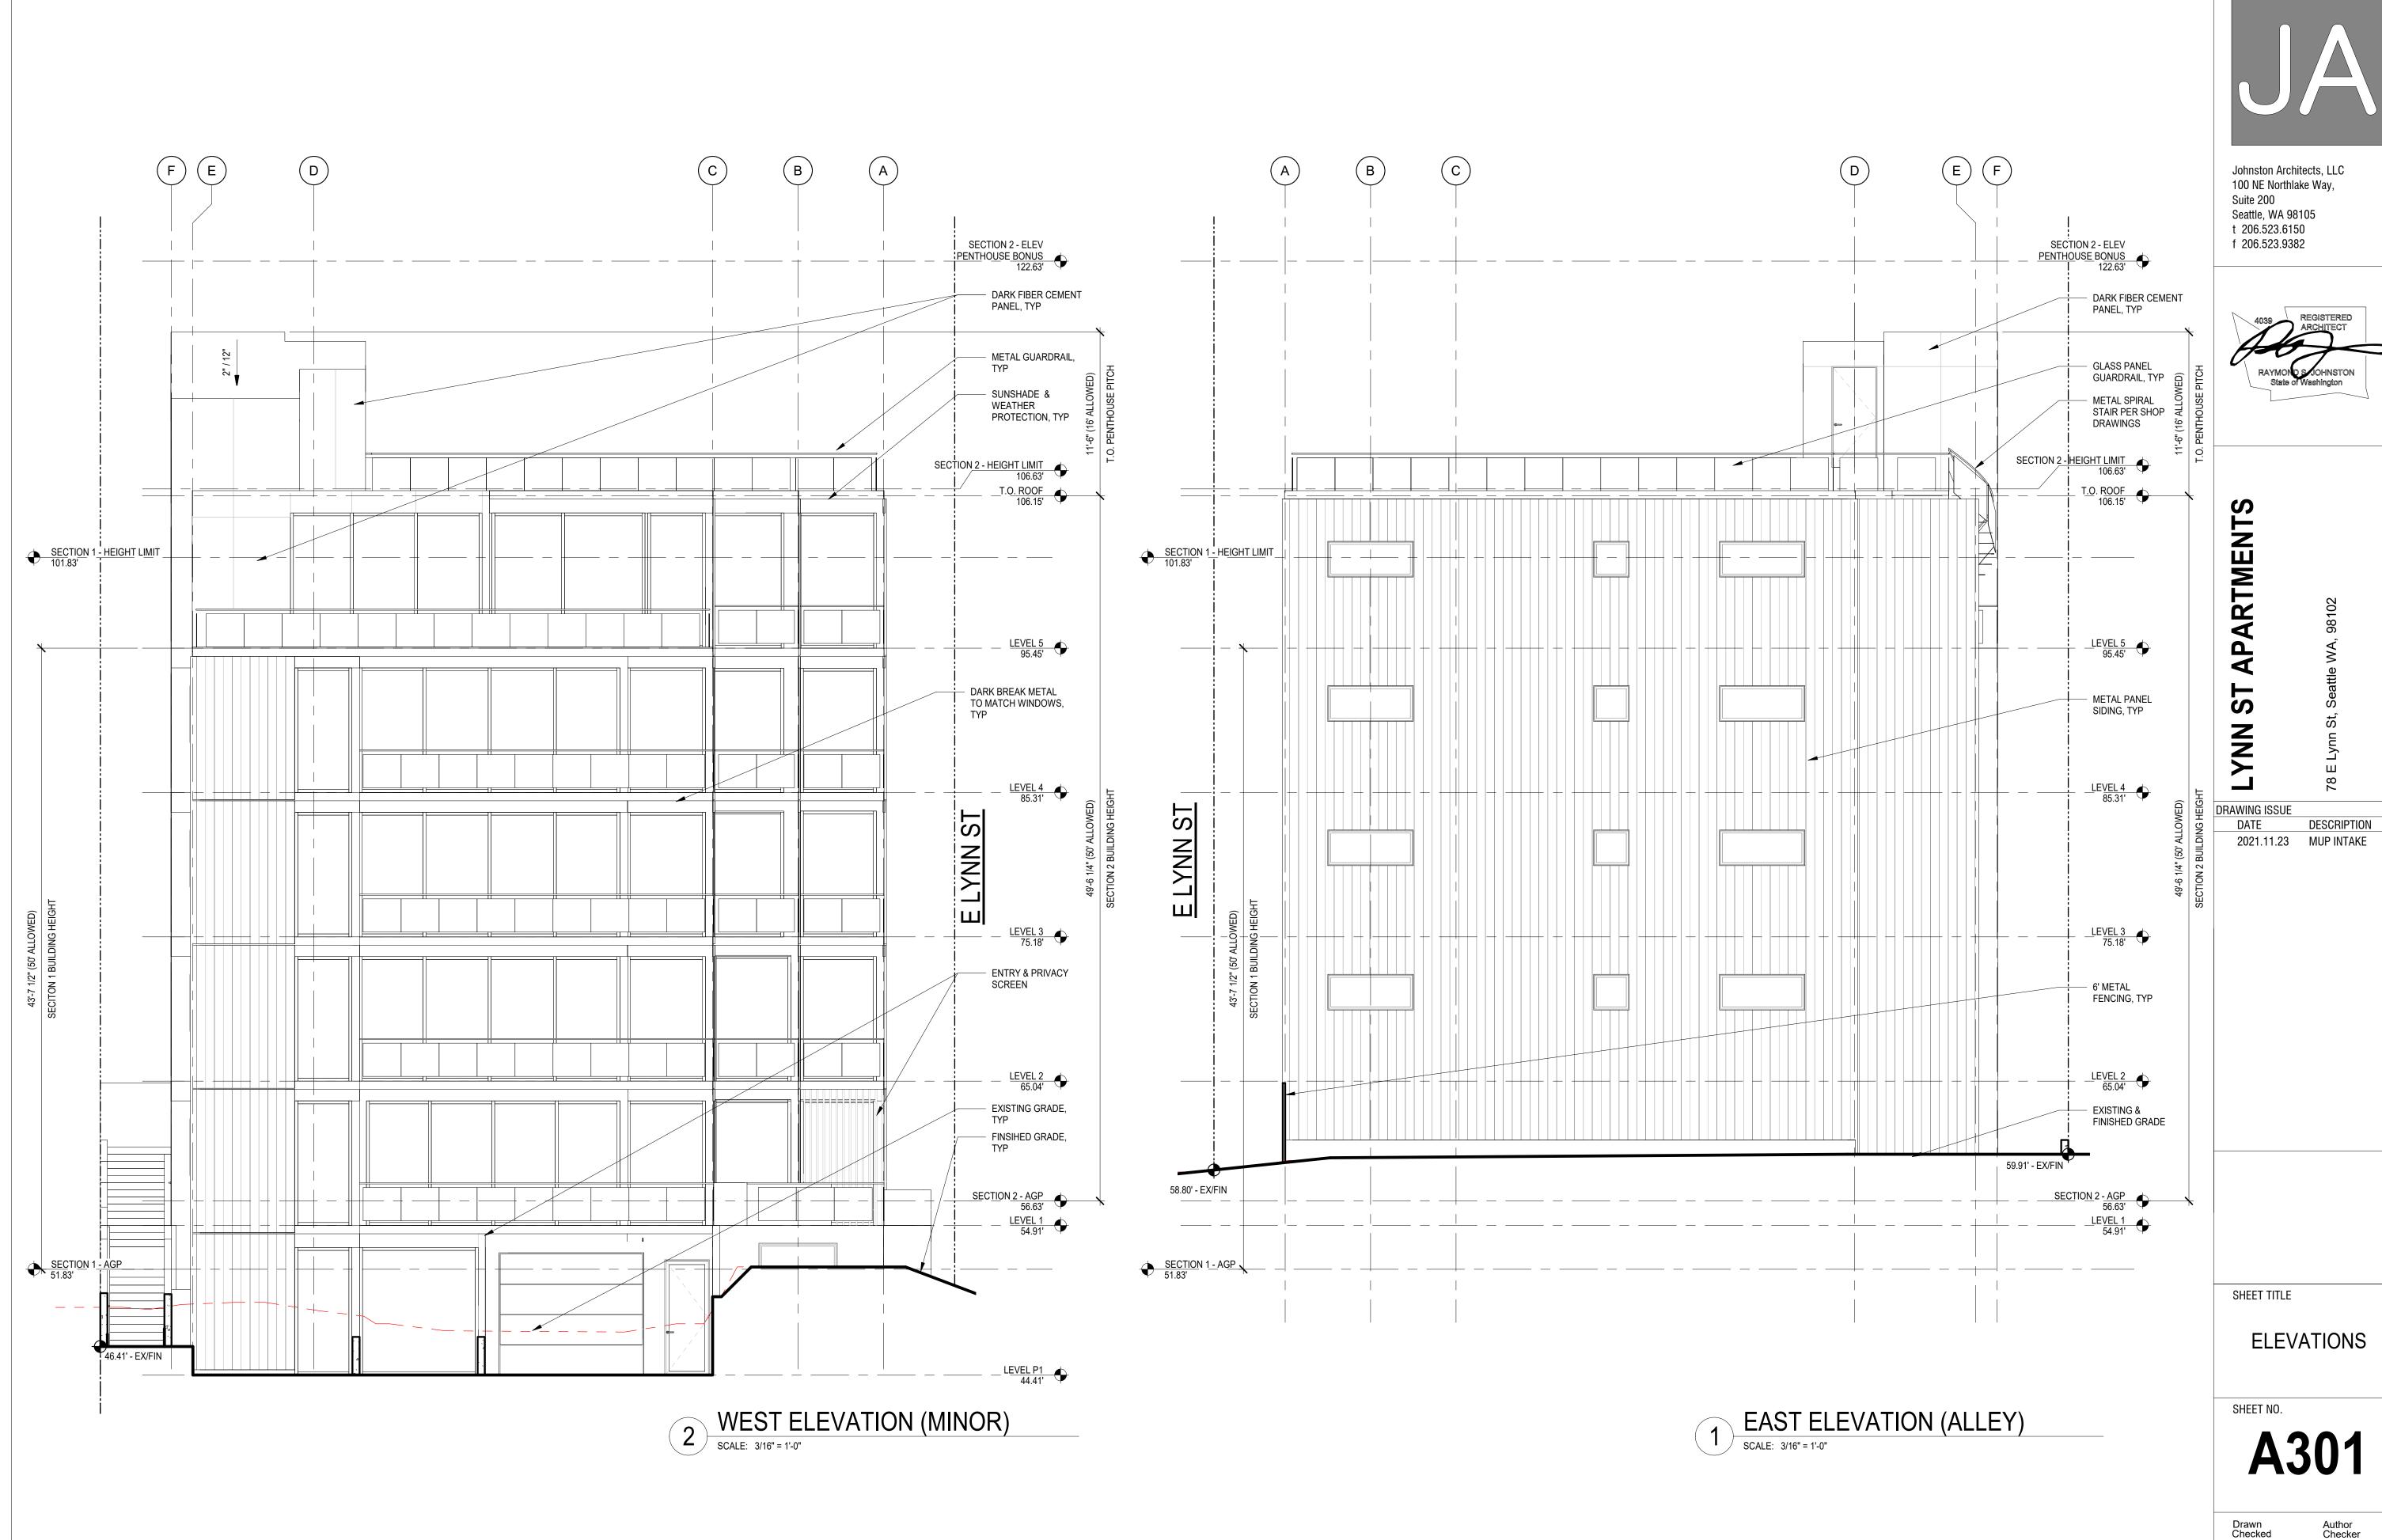



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APARTMENTS

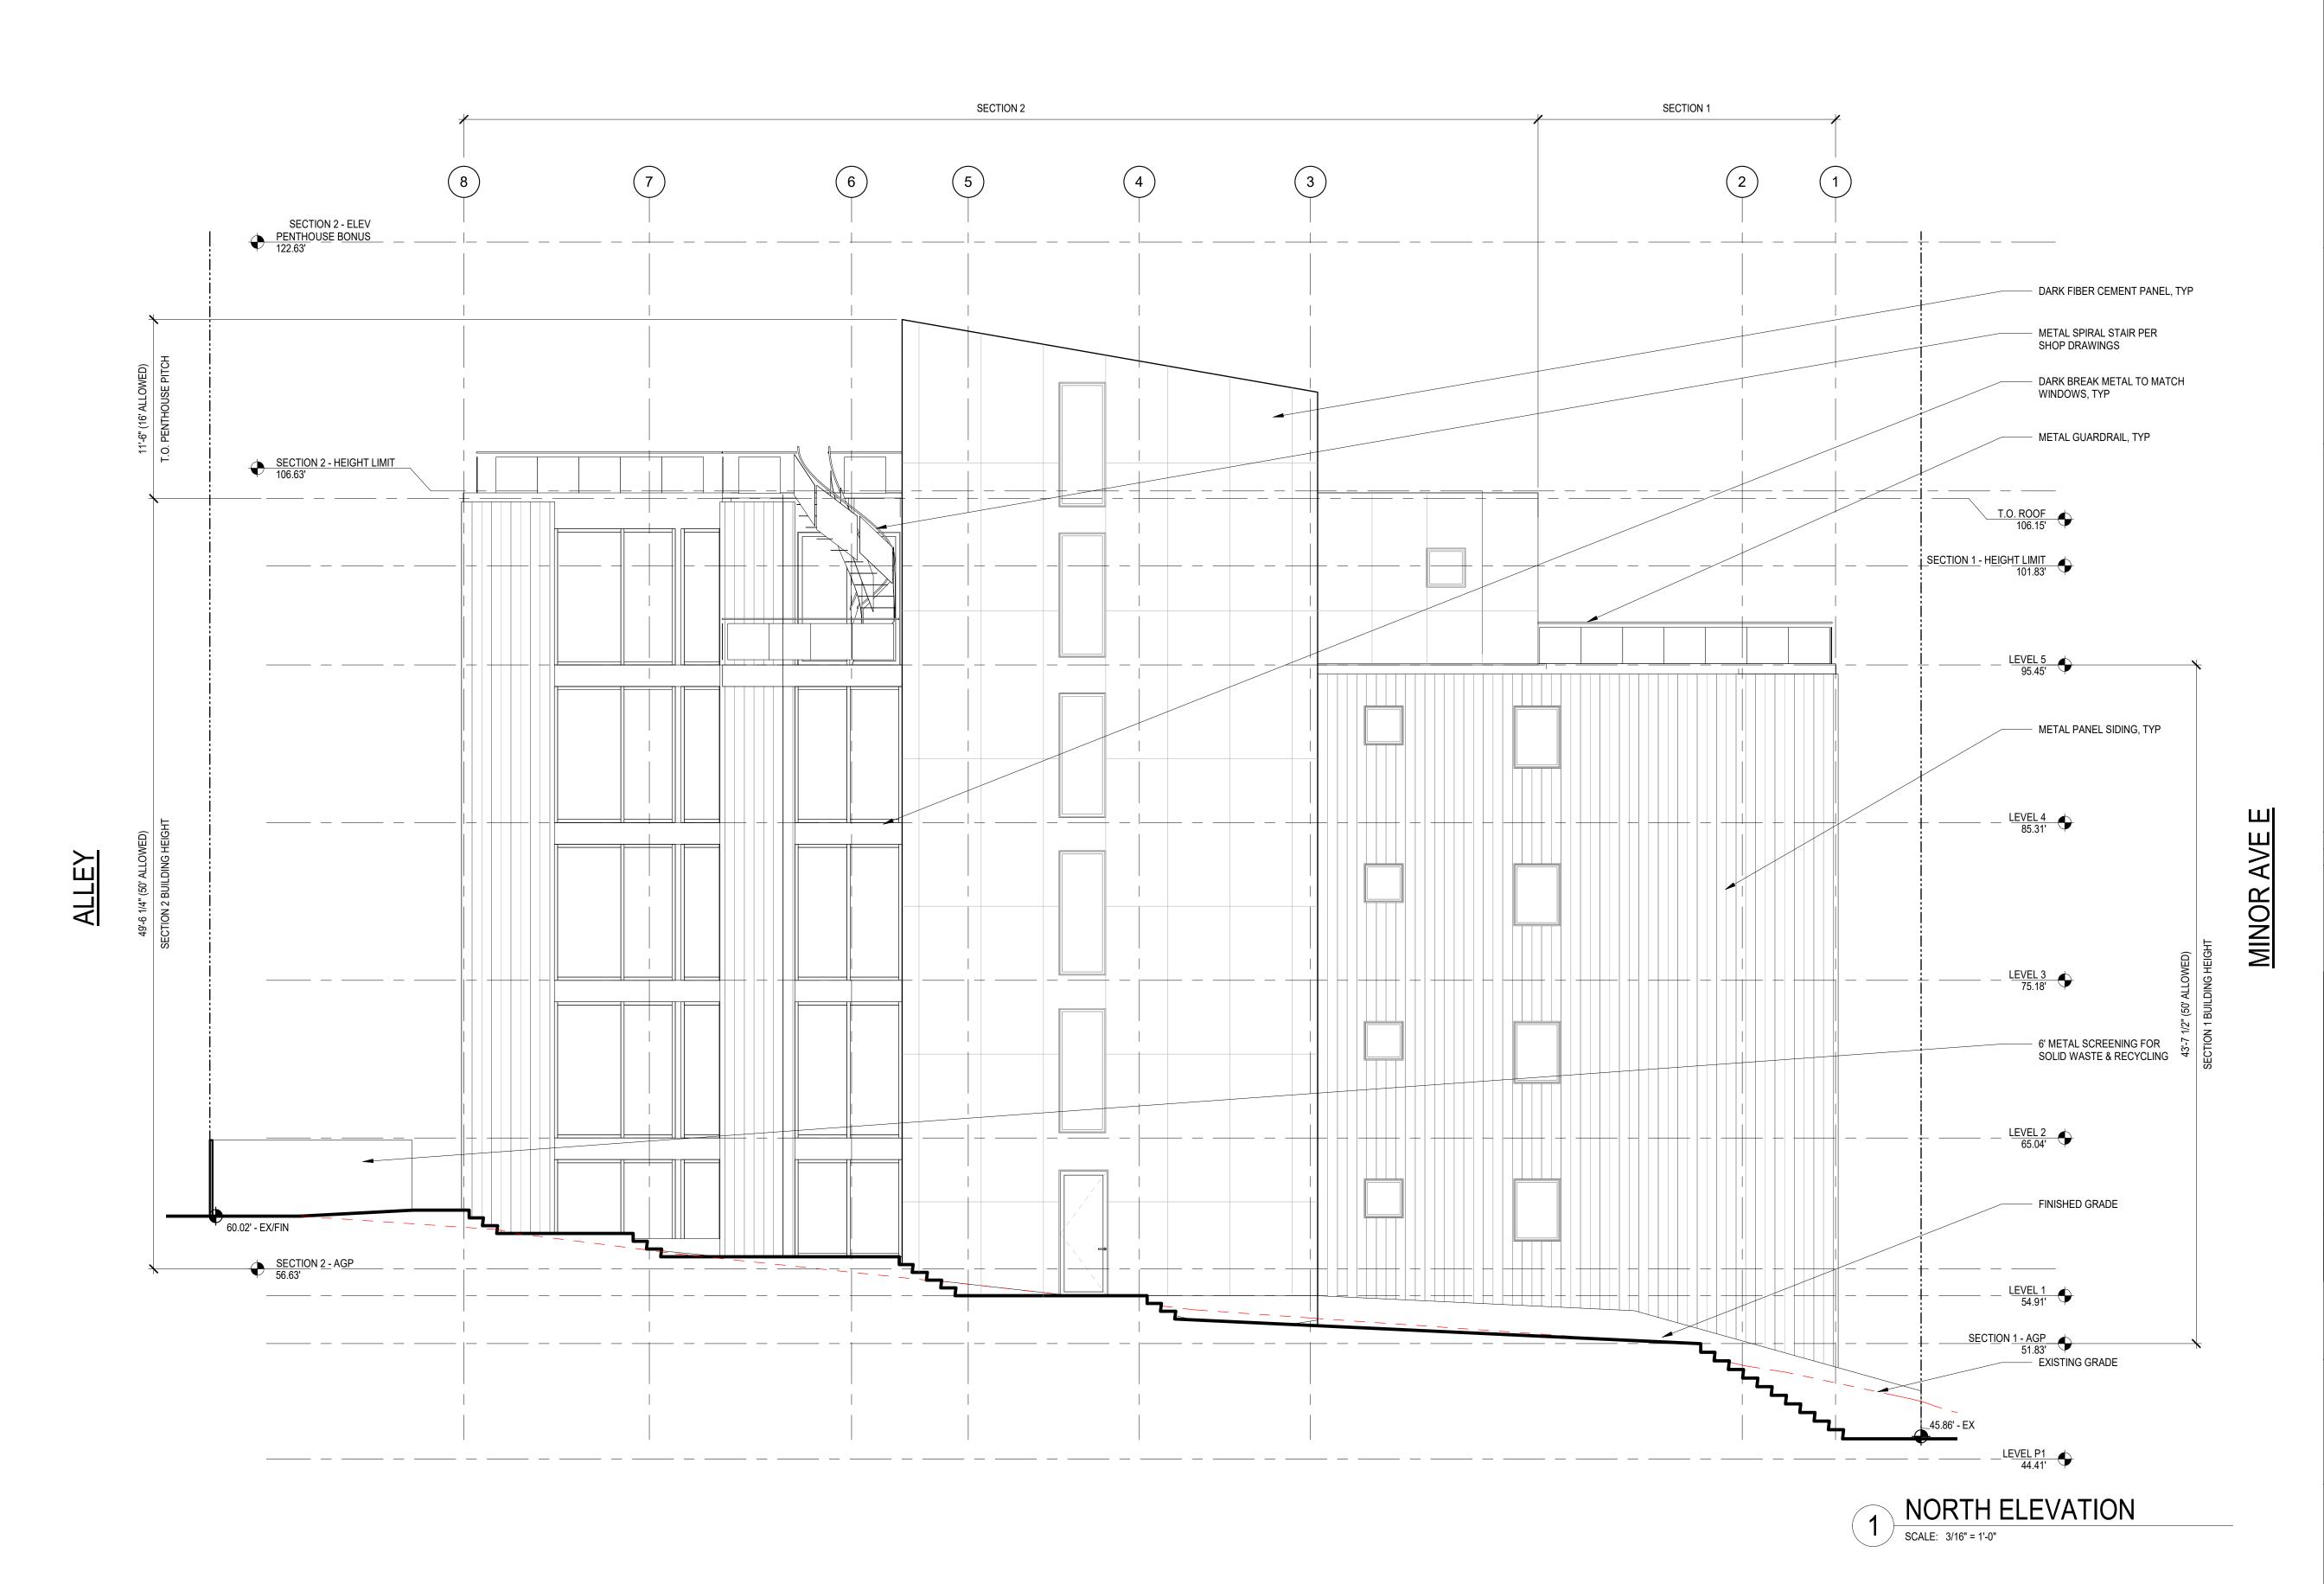78 E Lynn St, Seattle WA, 98102

DRAWING ISSUE

ST

DATE DESCRIPTION
2021.11.23 MUP INTAKE


SHEET TITLE

ELEVATIONS

SHEET NO.

A302



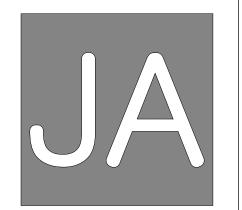



LYNN ST APARTMENTS

DRAWING ISSUE

DATE

DESCRIPTION

2021.11.23


MUP INTAKE

SHEET TITLE

COLORED ELEVATIONS

SHEET NO.

A303

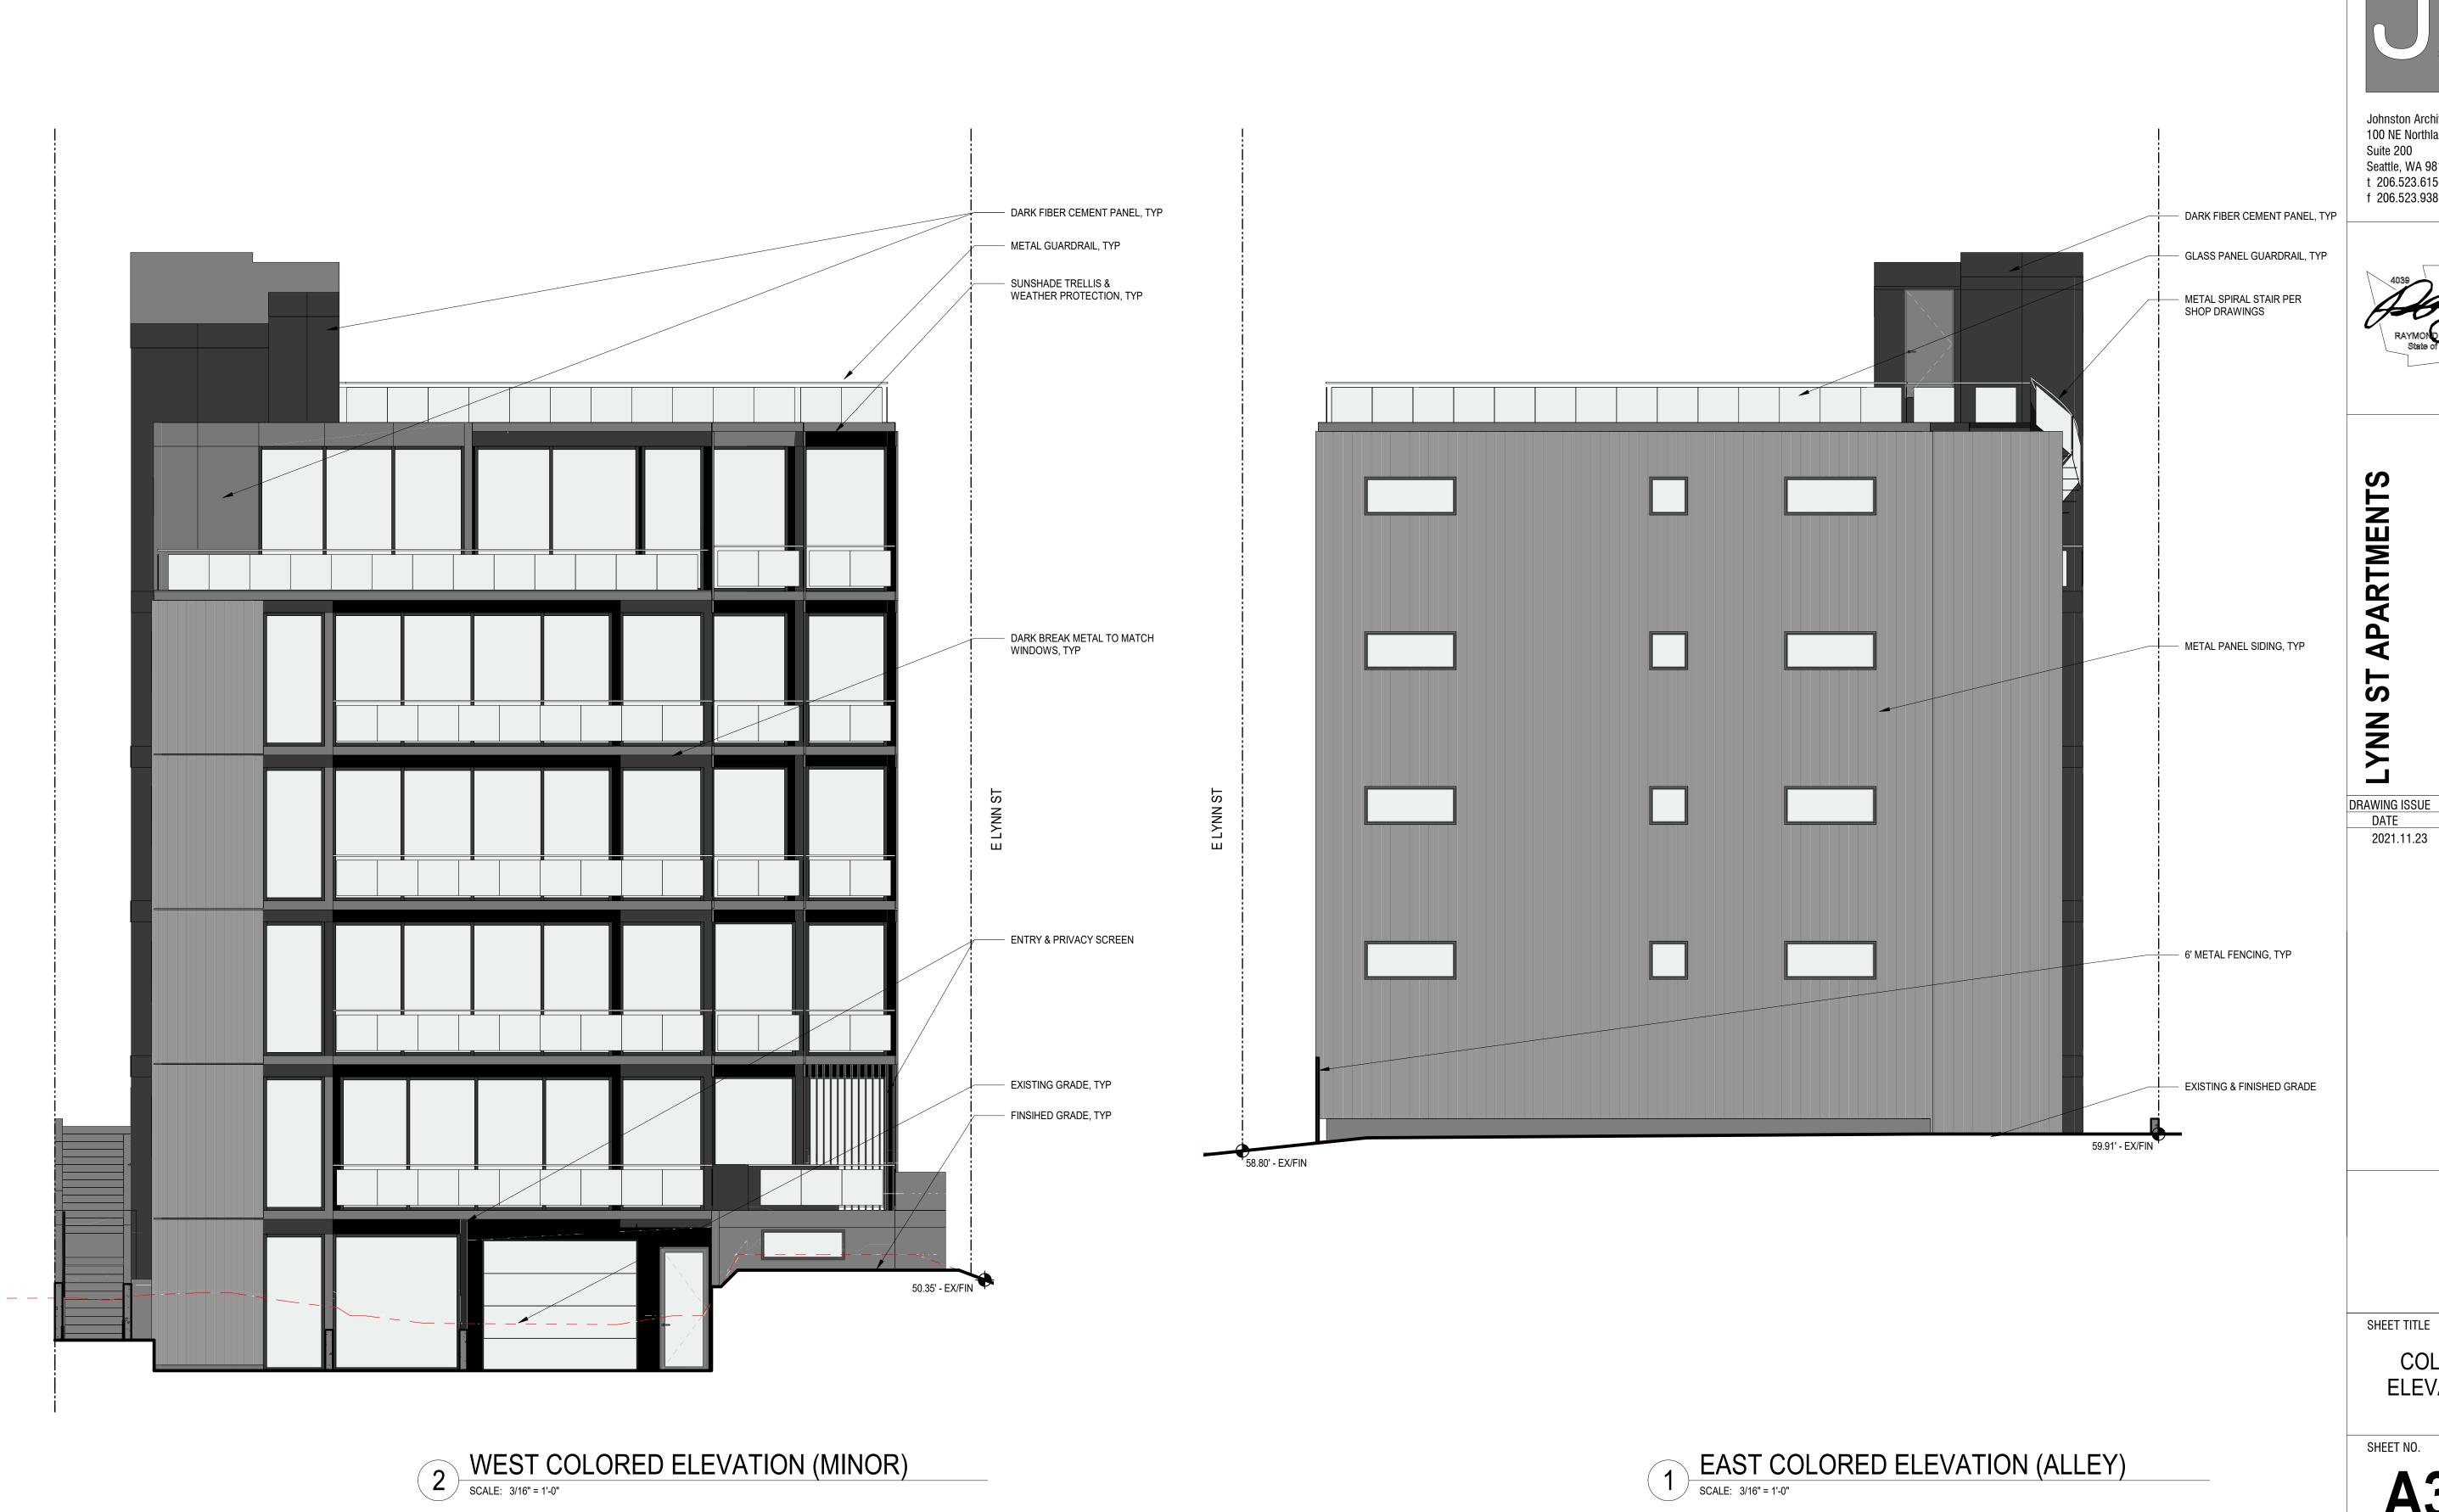




DESCRIPTION 2021.11.23 MUP INTAKE


COLORED **ELEVATIONS** 

A304

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N ST APARTMENTS

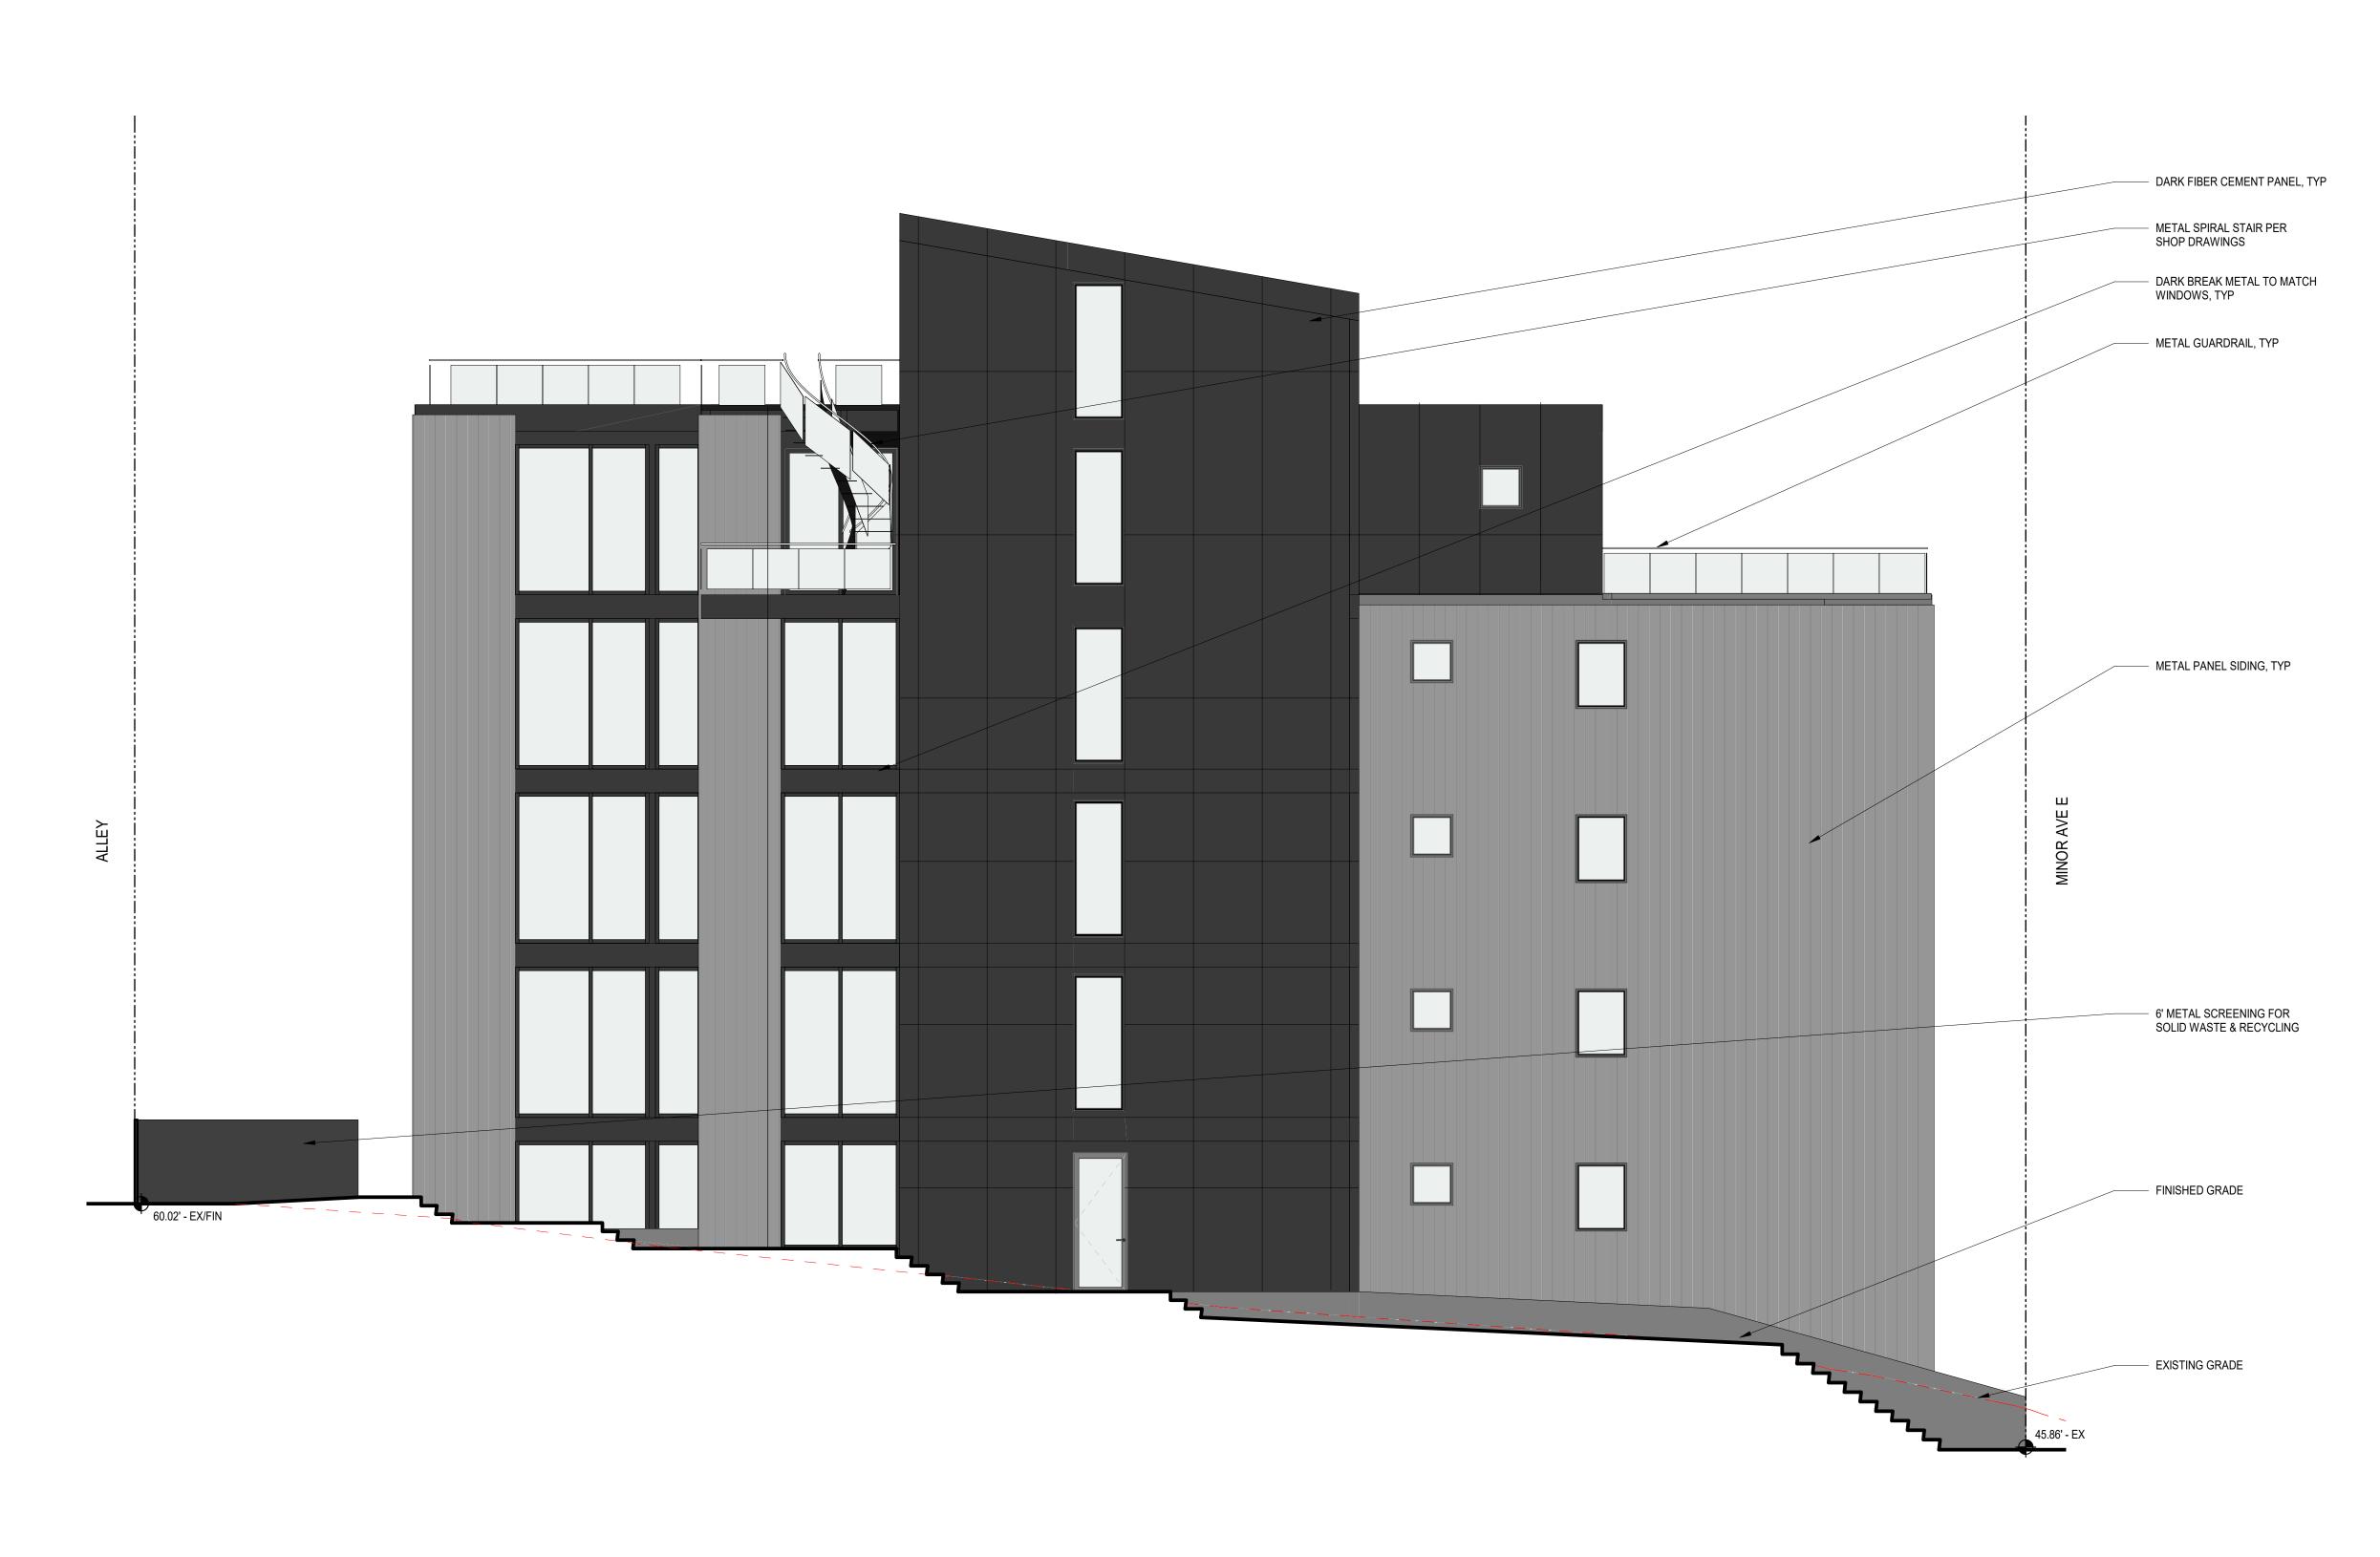DRAWING ISSUE

DESCRIPTION

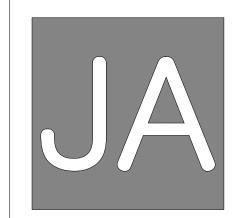
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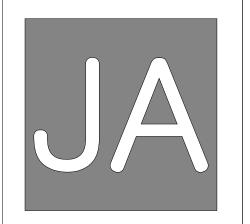
COLORED ELEVATIONS

SHEET NO.

SHEET TITLE

A305



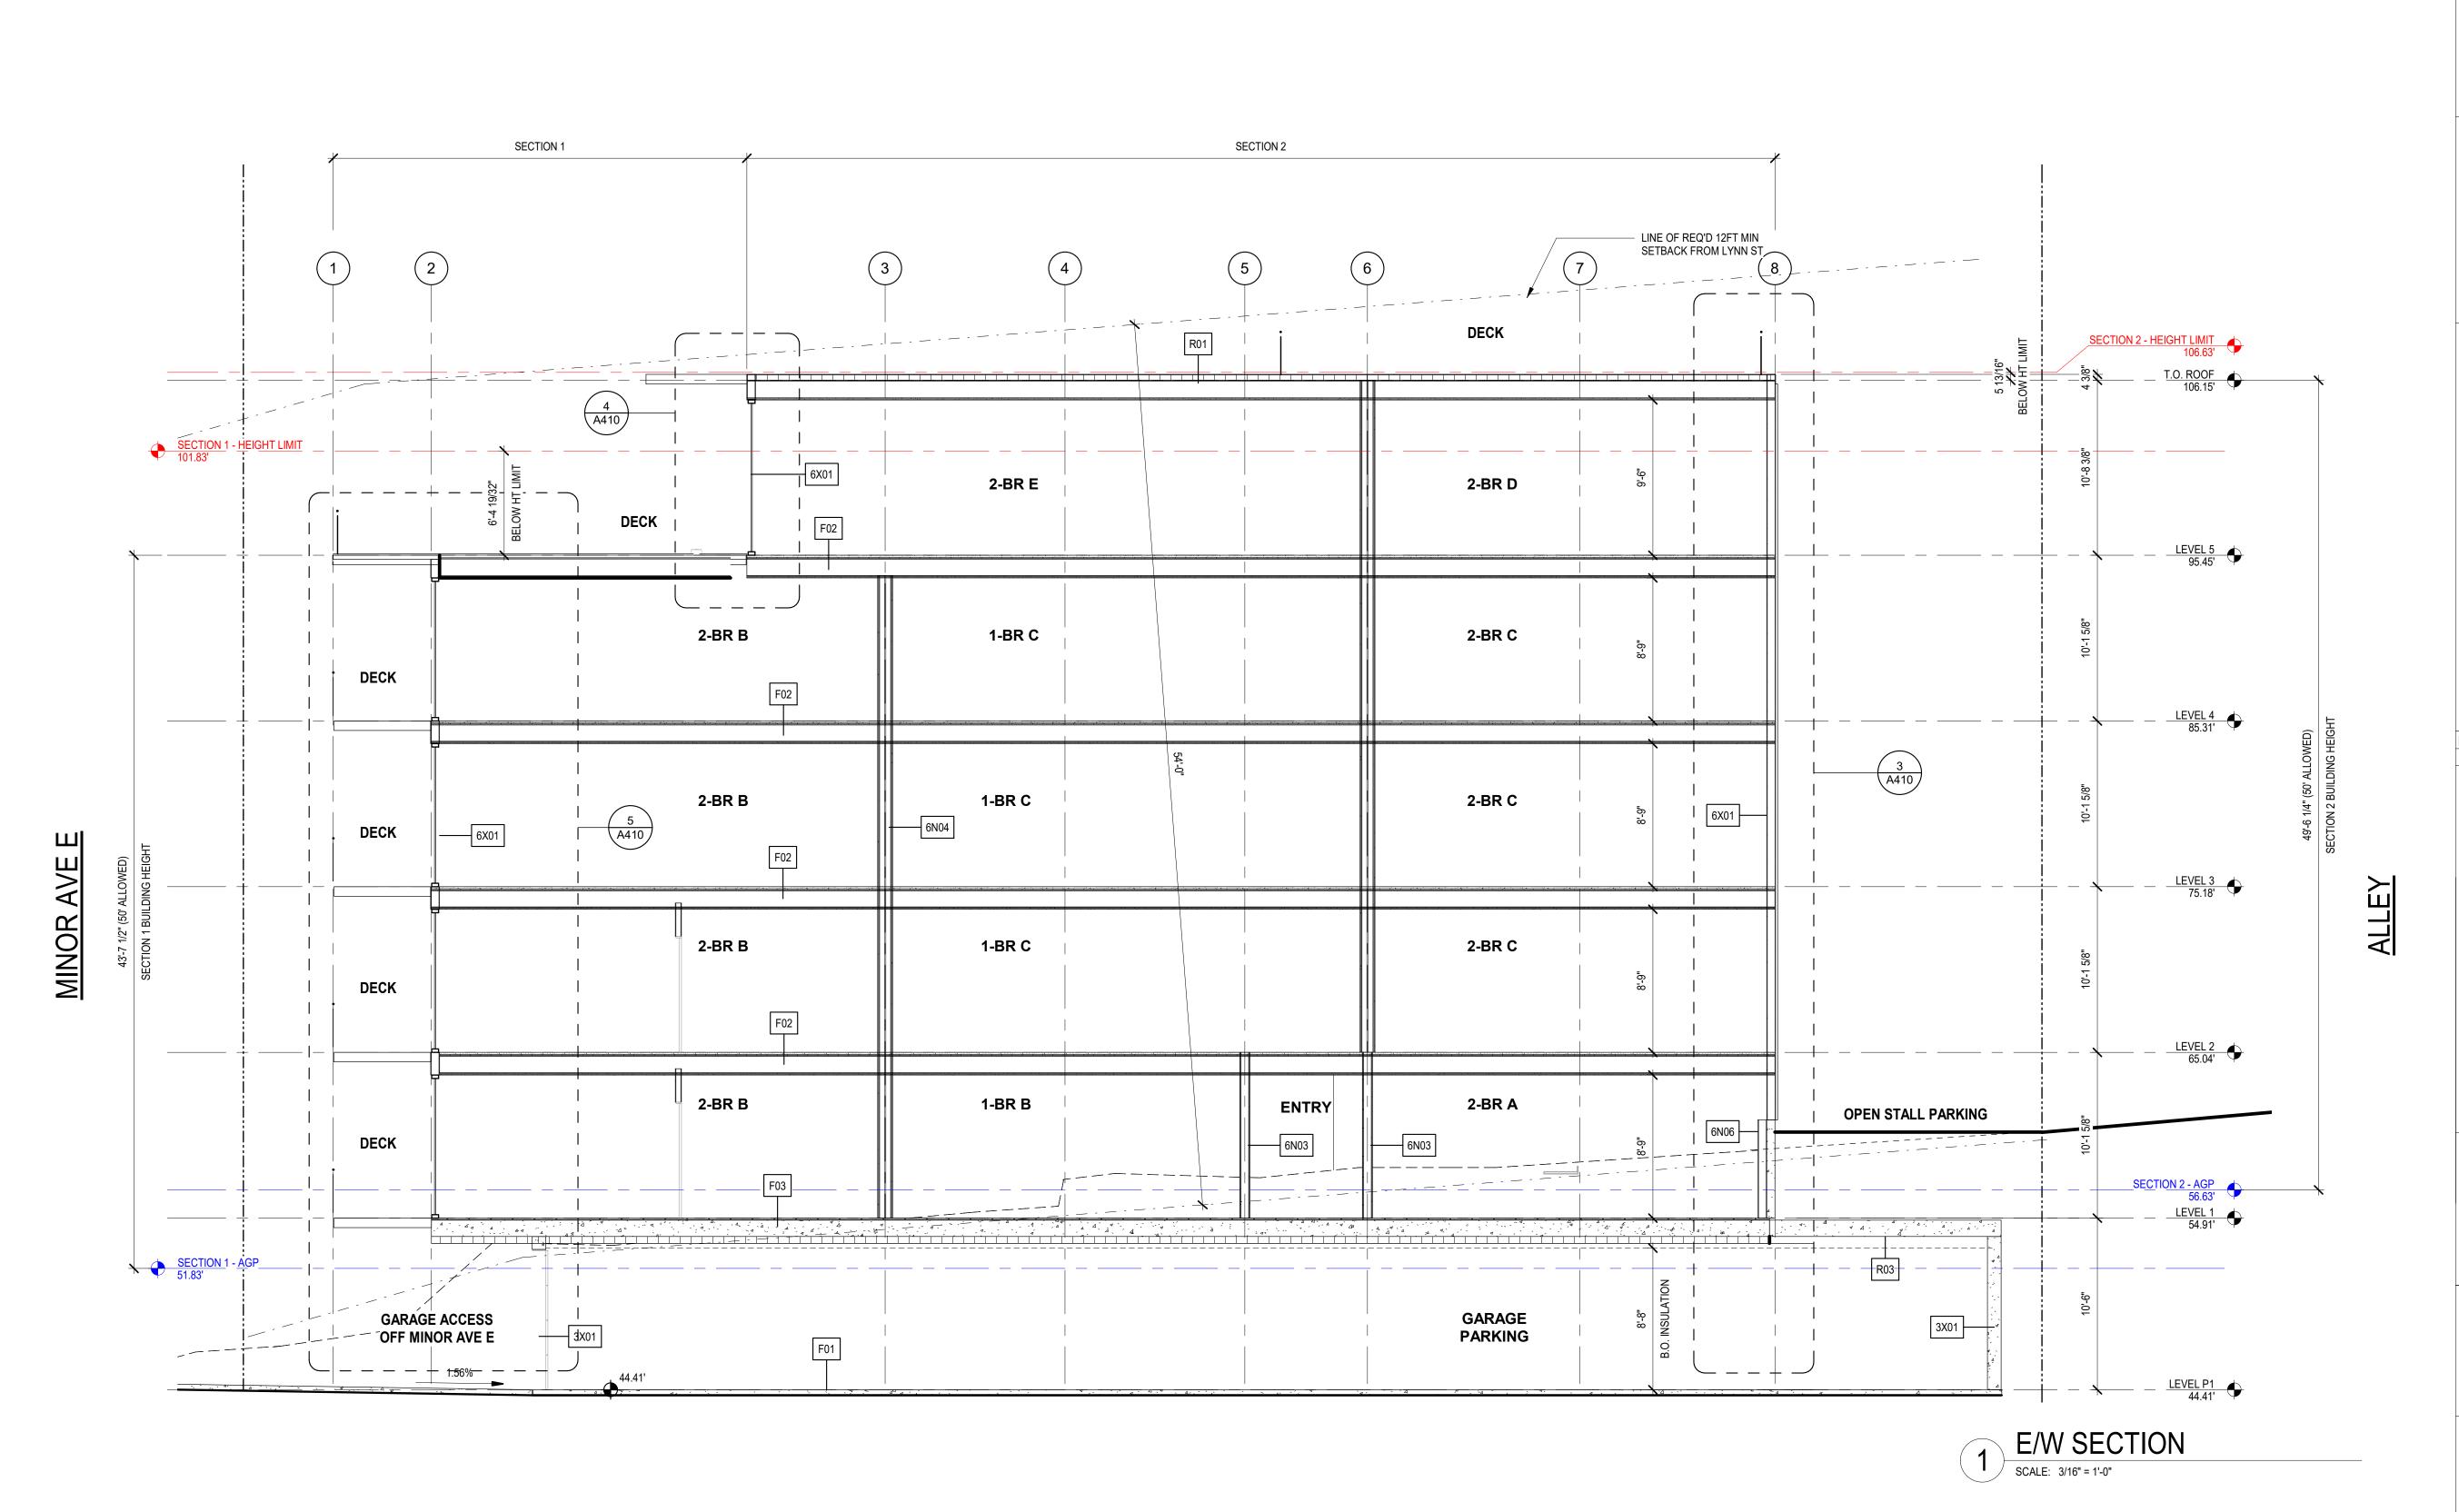



RAYMOND S JOHNSTON State of Washington

LYNN ST APARTMENTS

DRAWING ISSUE

DATE DESCRIPTION


2021.11.23 MUP INTAKE

SHEET TITLE


SECTIONS

SHEET NO.

**A400** 

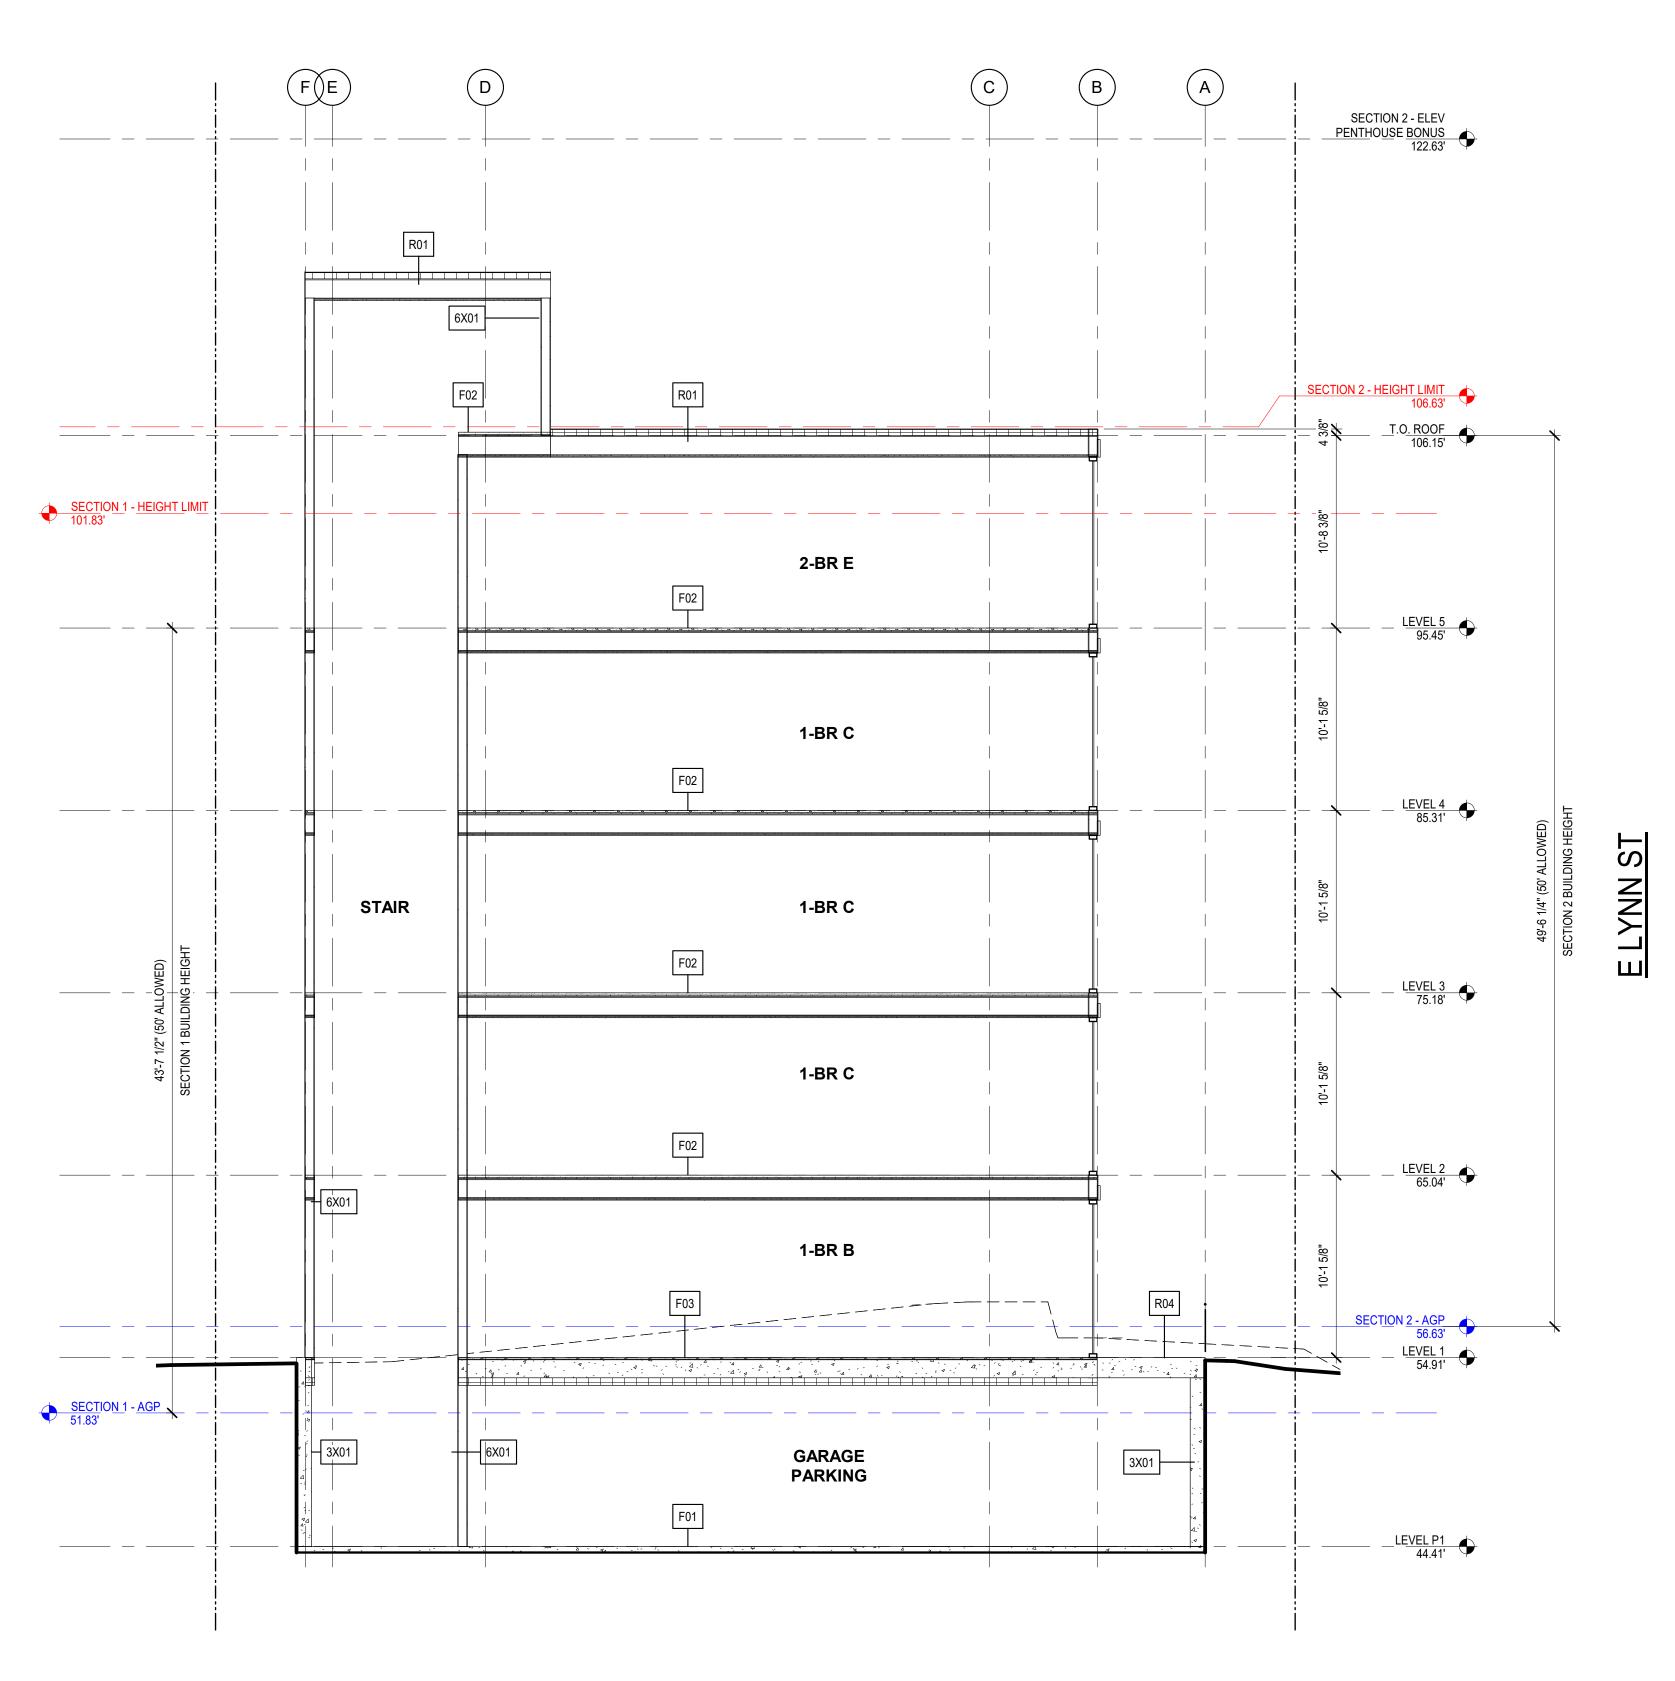



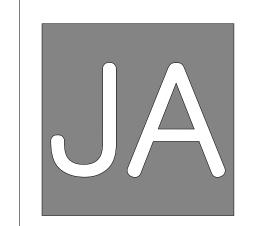



APARTMENTS

78 E Lynn St, Seattle WA, 98102

ST

DRAWING ISSUE

DATE

DESCRIPTION

2021.11.23 MUP INTAKE

SHEET TITLE

SECTIONS

SHEET NO.

A401

